



GENERAL NOTES

- 1. ALL IMPROVEMENTS SHOWN ON THESE CONSTRUCTION DRAWINGS SHALL BE IMPLEMENTED IN ACCORDANCE WITH BULLHEAD CITY, MAG AND ADOT SPECIFICATIONS.
- 2. THE CONTRACTOR SHALL BE RESPONSIBLE FOR SECURING AND OBTAINING ALL NECESSARY PERMITS, COMPLYING WITH ALL TERMS AND CONDITIONS IMPOSED BY THE PERMITTING.
- 3. FLOOD STATEMENT: ACCORDING TO FLOOD INSURANCE RATE MAP NO. 04015C4462G DATED NOVEMBER 18, 2009 FOR BULLHEAD CITY AND MOHAVE COUNTY, ARIZONA, THIS PROPERTY IS WITHIN "ZONE D" WHICH ARE AREAS THAT FLOOD HAZARDS ARE UNDETERMINED, BUT POSSIBLE.
- 4. THE CONTRACTOR SHALL PROVIDE AT LEAST 48 HOURS NOTICE TO EACH OF THE FOLLOWING AGENCIES PRIOR TO START OF CONSTRUCTION:
 BULLHEAD CITY (WASTEWATER) (928) 763-0166
 BULLHEAD CITY (WATER) (928) 763-9400
 SUDDENLINK (CABLE) (928) 758-4844
 FRONTIER COMMUNICATION (TELEPHONE) (877) 521-5443
 UNISOURCE ENERGY SERVICES (ELECTRIC) (877) 837-4968
 SOUTHWEST GAS COMPANY (GAS) (877) 860-6020
- 5. PRIOR TO BIDDING THE WORK AND/OR START OF CONSTRUCTION, THE CONTRACTOR SHALL THOROUGHLY SATISFY HIMSELF AS TO ACTUAL SITE CONDITIONS AND EARTHWORK QUANTITIES. NO CLAIM SHALL ME MADE AGAINST THE DESIGN ENGINEER FOR ANY EXCESS OR DEFICIENCY THEREIN, ACTUAL, OR RELATIVE.
- 6. THE DESIGN ENGINEER SHALL NOT BE RESPONSIBLE FOR CONSTRUCTION MEANS, METHODS, TECHNIQUES, SEQUENCES, OR PROCEDURES FOR SAFETY PRECAUTIONS OR PROGRAMS UTILIZED IN CONNECTION WITH THE WORK, AND WILL NOT BE RESPONSIBLE FOR THE CONTRACTOR'S FAILURE TO EXECUTE THE WORK IN ACCORDANCE WITH CONTRACT DOCUMENTS.
- 7. TOPOGRAPHIC INFORMATION HAS BEEN PROVIDED BY STOVALL LAND SURVEYING. IF THE CONTRACTOR DOES NOT ACCEPT THE EXISTING TOPOGRAPHY AS SHOWN ON THE PLANS, WITHOUT EXCEPTION, THE CONTRACTOR SHALL HAVE MADE, AT HIS EXPENSE, A TOPOGRAPHY SURVEY BY A REGISTERED LAND SURVEYOR.
- 8. ALL APPLICABLE LOCAL, STATE, AND NATIONAL SAFETY CODES AND REQUIREMENTS SHALL BE OBSERVED BY THE CONTRACTOR AT ALL TIMES DURING CONSTRUCTION.
- 9. THE CONTRACTOR SHALL EXERCISE CAUTION AND USE CONSTRUCTION TECHNIQUES TO PROTECT AND PRESERVE EXISTING PERMANENT SURVEY MONUMENTS. ALL MONUMENTS DISTURBED SHALL BE REPLACED AND/OR REHABILITATED IN ACCORDANCE WITH STANDARDS BY A PROFESSIONAL LAND SURVEYOR AT THE CONTRACTOR'S EXPENSE.
- 10. EXISTING UTILITIES ARE SHOWN IN AN APPROXIMATE MANNER ONLY. CONTRACTORS SHALL VERIFY SIZE, LOCATION, MATERIAL, AND ELEVATION OF ALL UNDERGROUND UTILITIES, WHETHER OR NOT SHOWN ON THE DRAWINGS, AS NECESSARY TO ACCOMMODATE PROPOSED CONSTRUCTION.
- 11. THE CONTRACTOR SHALL KEEP SUITABLE EQUIPMENT AT THE JOB SITE FOR MAINTAINING DUST CONTROL AND SHALL CONTROL DUST AS DIRECTED BY THE OWNERS REPRESENTATIVE AND CITY OR COUNTY INSPECTORS.
- 12. NO PROJECT WILL BE CONSIDERED COMPLETE UNTIL ALL CLEAN-UP IS COMPLETE INCLUDING BUT NOT LIMITED TO CURBS, PAVEMENTS AND SIDEWALKS BEING SWEPT CLEAN OF AL DIRT AND DEBRIS.
- 13. ANY WORK AND MATERIAL NOT IN CONFORMANCE WITH THE PLANS AND SPECIFICATIONS IS SUBJECT TO REMOVAL AND REPLACEMENT AT THE CONTRACTORS EXPENSE.
- 14. ALL TRAFFIC CONTROL SHALL BE INSTALLED ACCORDING TO THE GOVERNING AUTHORITIES REQUIREMENTS AND THE LATEST EDITION OF THE MUTCD. ALL TRAFFIC CONTROL DEVICES SHALL BE MAINTAINED FOR THE DURATION OF THE WORK. ALL DEVICES SHALL BE IN GOOD REPAIR AND MEET THE PERFORMANCE REQUIREMENTS OF THE MUTCD.
- 15. NO CHANGES TO THE SET OF IMPROVEMENT PLANS APPROVED FOR CONSTRUCTION WILL BE ALLOWED UNLESS WRITTEN PERMISSION IS OBTAINED FROM THE ENGINEER OF RECORD OR OWNER AND PROPOSED CHANGES SUBMITTED TO BULLHEAD CITY FOR REVIEW AND RE-ACCEPTANCE.
- 16. ANY DISCREPANCIES IN THE DRAWINGS SHALL BE IMMEDIATELY BROUGHT TO THE ATTENTION OF THE OWNER BEFORE COMMENCING WORK. NO FIELD CHANGES OR DEVIATIONS FROM THE APPROVED PLANS ARE TO BE MADE WITHOUT PRIOR APPROVAL OF THE OWNER AND NOTIFICATION TO THE ENGINEER. NO CONSIDERATION WILL BE GIVEN TO CHANGE ORDERS FOR WHICH THE OWNER AND ENGINEER WERE NOT CONTACTED PRIOR TO CONSTRUCTION OF THE AFFECTED
- 17. REMOVAL AND REPLACEMENT QUANTITIES ARE APPROXIMATE AND ARE SHOWN FOR INFORMATIONAL PURPOSES ONLY. THE CONTRACTOR SHALL BE RESPONSIBLE FOR THE COMPLETENESS AND ACCURACY OF A DETAILED ESTIMATE BASED ON THESE PLANS, CURRENT CODES AND SITE VISITS.
- 18. THE ENGINEER AND APPLICABLE AGENCY MUST APPROVE, PRIOR TO CONSTRUCTION, ANY ALTERATION OR VARIANCE FROM THESE PLANS. ANY VARIATIONS FROM THESE PLANS SHALL BE PROPOSED ON CONSTRUCTION FIELD PRINTS AND TRANSMITTED TO THE ENGINEER.
- 19. THE ENGINEER HAS NOT BEEN RETAINED BY THE OWNER TO PROVIDE AS-BUILT SERVICES. THE CONTRACTOR SHALL PROVIDE THE APPROPRIATE PROFESSIONAL TO PROVIDE ALL NECESSARY AS-BUILT INFORMATION TO ENABLE ALL FINAL APPROVALS, INSPECTIONS, AND CERTIFICATES FROM ALL NECESSARY JURISDICTIONS.
- 20. NOTHING CONTAINED IN THE CONTRACT DOCUMENTS SHALL CREATE, NOR SHALL BE CONSTRUED TO CREATE ANY CONTRACTUAL RELATIONSHIP BETWEEN THE DESIGN ENGINEER AND THE CONTRACTOR OR ANY SUBCONTRACTOR.
- 21. THE PROJECT IS DESIGNED ON LOCAL COORDINATE SYSTEM.

STORMWATER RUNOFF MANAGEMENT

- 1. THE OWNER, SITE DEVELOPER, CONTRACTOR AND/OR THEIR AUTHORIZED AGENTS SHALL EACH DAY REMOVE ALL SEDIMENT, MUD, CONSTRUCTION DEBRIS, OR OTHER POTENTIAL POLLUTANTS THAT MAY HAVE BEEN DISCHARGED TO, OR ACCUMULATED IN, THE PUBLIC RIGHTS OF WAY OF BULLHEAD CITY AS A RESULT OF CONSTRUCTION ACTIVITIES ASSOCIATED WITH THIS SITE DEVELOPMENT OR CONSTRUCTION PROJECT. SUCH MATERIALS SHALL BE PREVENTED FROM ENTERING THE STORM SEWER SYSTEM.
- 2. ADDITIONAL CONSTRUCTION SITE DISCHARGE BEST MANAGEMENT PRACTICES MAY BE REQUIRED OF THE OWNER AND HIS OR HER AGENTS DUE TO UNFORESEEN EROSION PROBLEMS OR IF THE SUBMITTED PLAN DOES NOT MEET THE PERFORMANCE STANDARDS SPECIFIED IN CONSTRUCTION SITE BEST MANAGEMENT PRACTICES GUIDANCE MANUAL.
- 3. TEMPORARY OR PERMANENT STABILIZATION PRACTICES WILL BE INSTALLED ON DISTURBED AREAS AS SOON AS POSSIBLE AND NOT LATER THAN 14 DAYS AFTER THE CONSTRUCTION ACTIVITY IN THAT PORTION OF THE SITE HAS TEMPORARILY OR PERMANENTLY CEASED. SOME EXCEPTIONS MAY APPLY; REFER TO ARIZONA STORMWATER GENERAL PERMIT FOR CONSTRUCTION ACTIVITY.
- 4. AT A MINIMUM, THE CONTRACTOR OR HIS AGENT SHALL INSPECT ALL DISTURBED AREAS, AREAS USED FOR STORAGE OF MATERIALS AND EQUIPMENT THAT ARE EXPOSED TO PRECIPITATION, VEHICLE ENTRANCE AND EXIT LOCATIONS, AND ALL BMPs WEEKLY, AND WITHIN 24 HOURS AFTER ANY RAIN EVENT OF 0.5 INCHES OR GREATER. THE CONTRACTOR OR HIS AGENT SHALL UPDATE OR MODIFY THE STORMWATER POLLUTION PREVENTION PLAN AS NECESSARY. SOME EXCEPTIONS TO WEEKLY INSPECTIONS MAY APPLY, SUCH AS SUSPENSION OF LAND DISTURBANCE ACTIVITIES. REFER TO THE ARIZONA STORMWATER GENERAL PERMIT FOR CONSTRUCTION ACTIVITIES.
- 5. ACCUMULATED SEDIMENT IN BMPs SHALL BE REMOVED WITHIN SEVEN DAYS AFTER A STORMWATER RUNOFF EVENT OR PRIOR TO THE NEXT ANTICIPATED STORM EVENT, WHICHEVER IS EARLIER. SEDIMENT MUST BE REMOVED WHEN THE BMP DESIGN CAPACITY HAS BEEN REDUCED BY 50 PERCENT OR MORE.

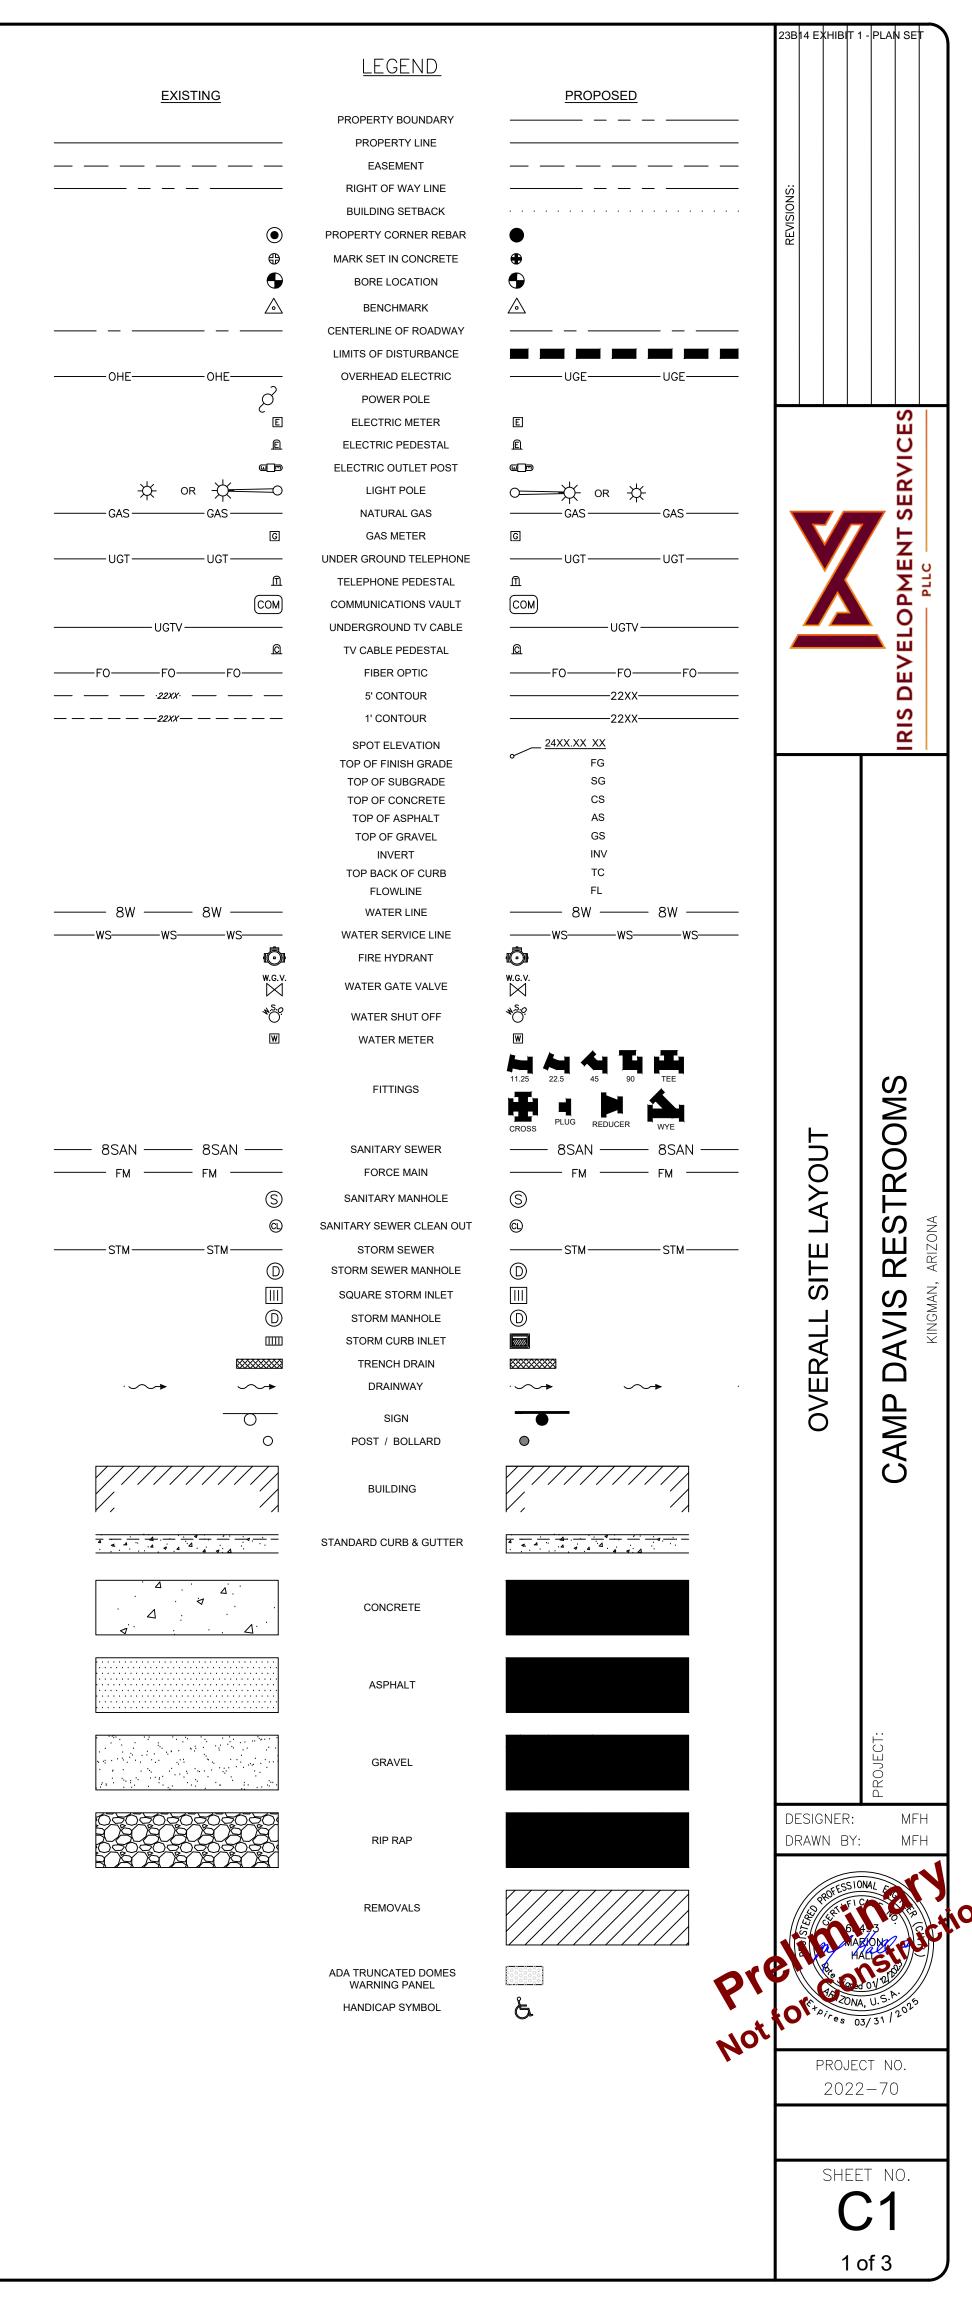

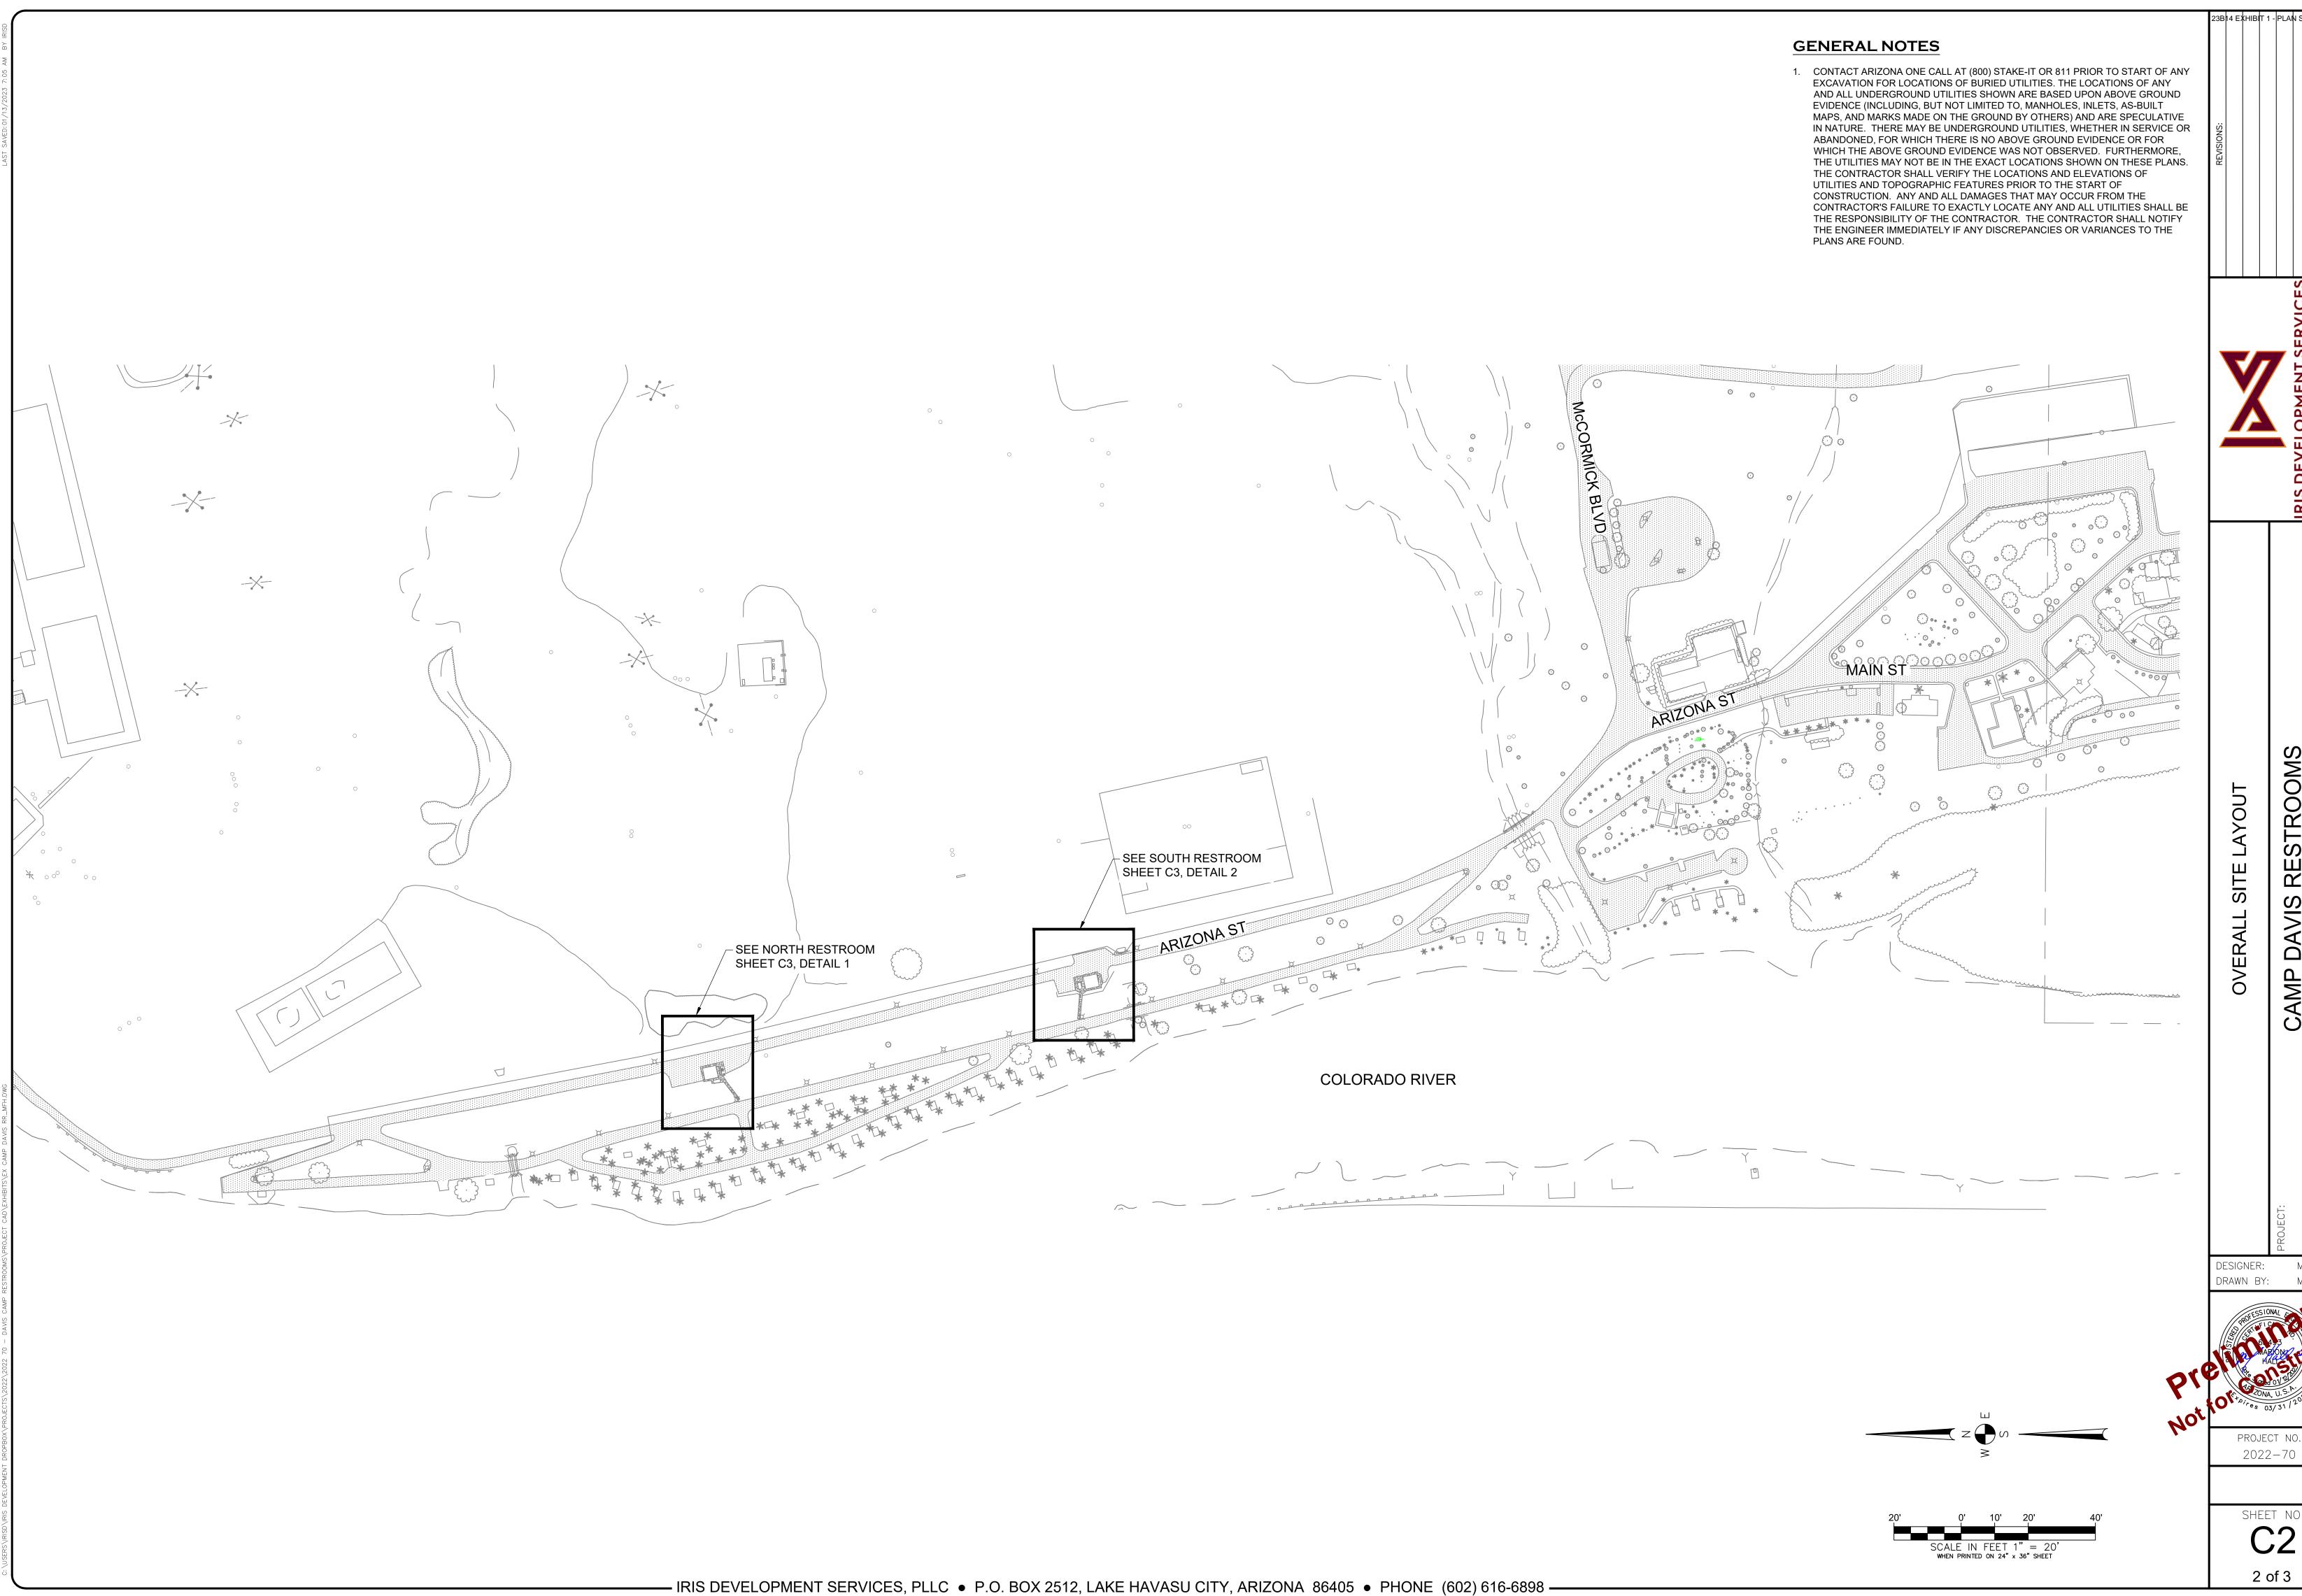


CAMP DAVIS REST

DESIGNER: MFH


PROJECT NO.

SHEET NO.

2 of 3

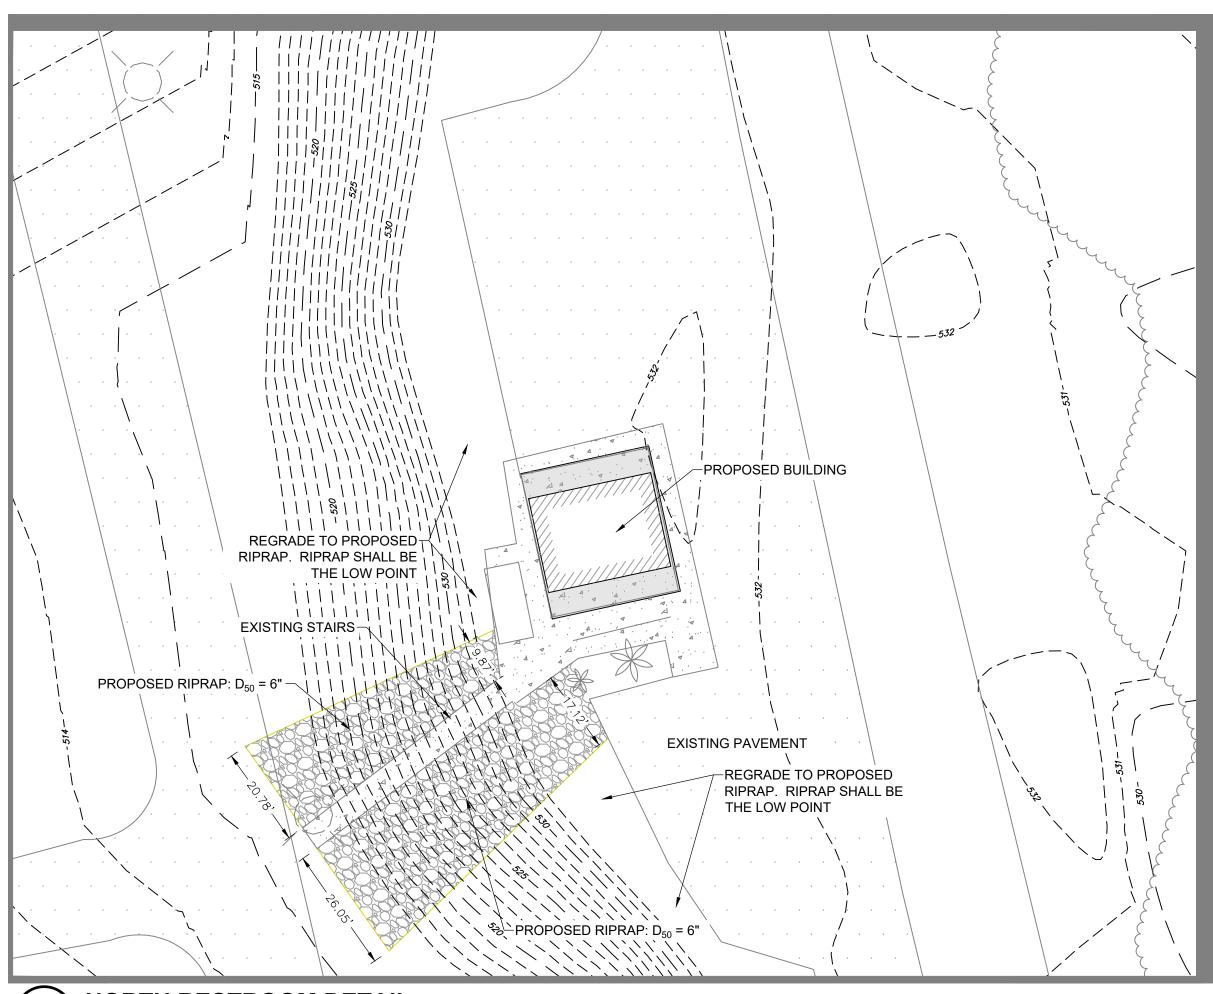

1 NORTH RESTROOM DETAIL
C3 SCALE: 1"=20"

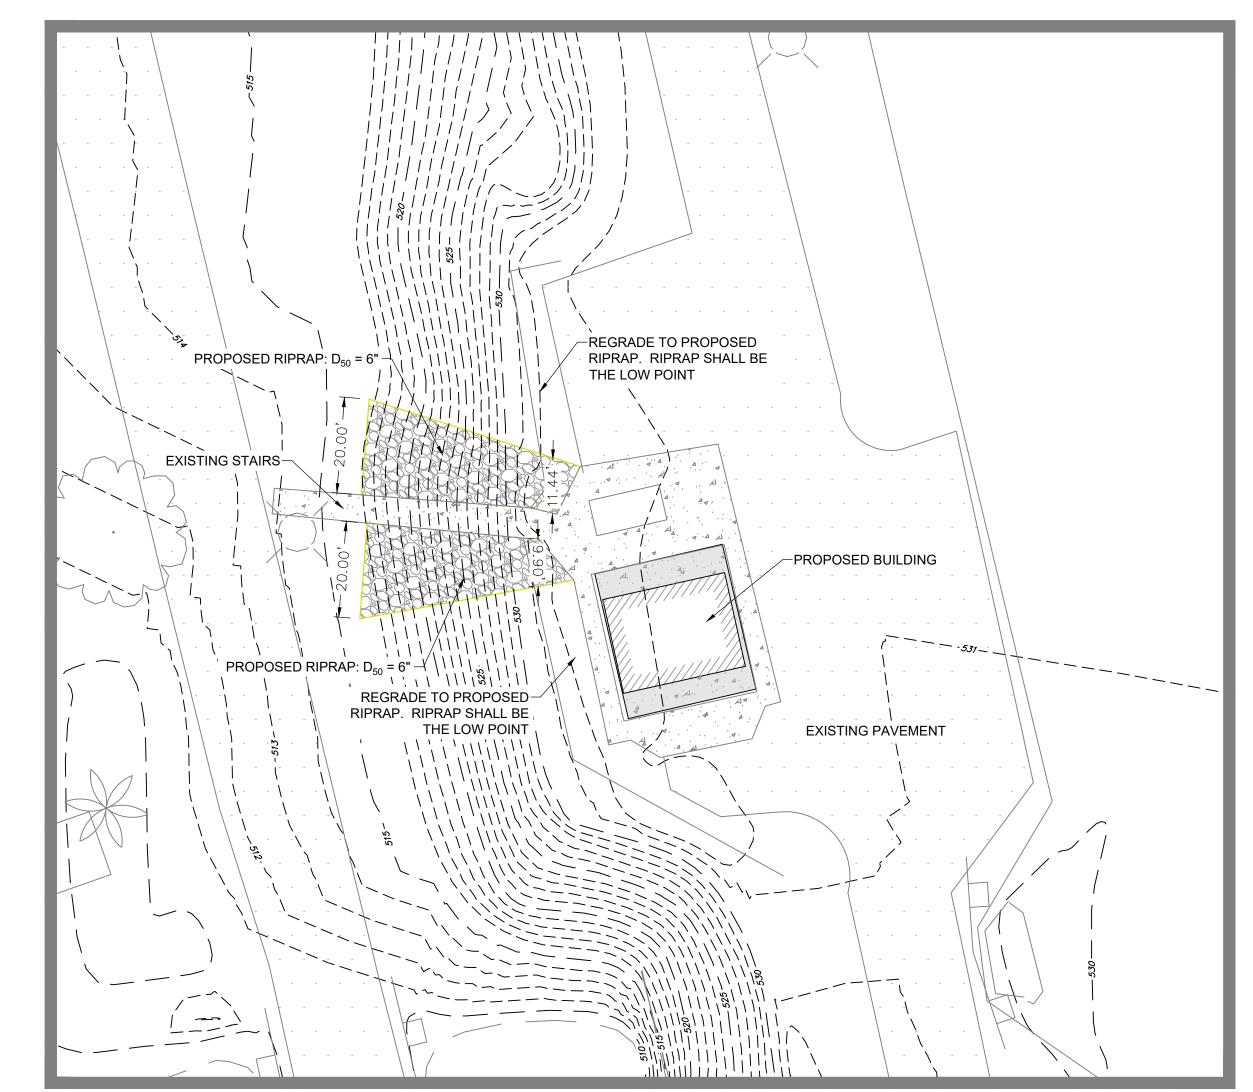

2 SOUTH RESTROOM DETAIL
C3 SCALE: 1"=20'

GENERAL NOTES

PLANS ARE FOUND.

1. CONTACT ARIZONA ONE CALL AT (800) STAKE-IT OR 811 PRIOR TO START OF ANY EXCAVATION FOR LOCATIONS OF BURIED UTILITIES. THE LOCATIONS OF ANY AND ALL UNDERGROUND UTILITIES SHOWN ARE BASED UPON ABOVE GROUND EVIDENCE (INCLUDING, BUT NOT LIMITED TO, MANHOLES, INLETS, AS-BUILT MAPS, AND MARKS MADE ON THE GROUND BY OTHERS) AND ARE SPECULATIVE IN NATURE. THERE MAY BE UNDERGROUND UTILITIES, WHETHER IN SERVICE OR ABANDONED, FOR WHICH THERE IS NO ABOVE GROUND EVIDENCE OR FOR WHICH THE ABOVE GROUND EVIDENCE WAS NOT OBSERVED. FURTHERMORE, THE UTILITIES MAY NOT BE IN THE EXACT LOCATIONS SHOWN ON THESE PLANS. THE CONTRACTOR SHALL VERIFY THE LOCATIONS AND ELEVATIONS OF UTILITIES AND TOPOGRAPHIC FEATURES PRIOR TO THE START OF CONSTRUCTION. ANY AND ALL DAMAGES THAT MAY OCCUR FROM THE CONTRACTOR'S FAILURE TO EXACTLY LOCATE ANY AND ALL UTILITIES SHALL BE THE RESPONSIBILITY OF THE CONTRACTOR. THE CONTRACTOR SHALL NOTIFY THE ENGINEER IMMEDIATELY IF ANY DISCREPANCIES OR VARIANCES TO THE

SEVELOPMENT SERVIC

SITE LAYOUT

1P DAVIS RESTROOMS

DESIGNER: MFH

DESIGNER:
DRAWN BY:

ROPESIONAL FOR PROPERTY OF THE PROPERTY OF THE

PROJECT NO. 2022-70

SHEET NO.

3 of 3

SCALE IN FEET 1" = 20' WHEN PRINTED ON 24" x 36" SHEET

DAVIS CAMP PARK RESTROOMS

BULLHEAD CITY, ARIZONA

ARCHITECT: (DESIGN PROFESSIONAL IN RESPONSIBLE CHARGE)

SELBERG ASSOCIATES, INC.

TODD BRAUTIGAM, A.I.A. 2130 MESQUITE AVE. SUITE 204 LAKE HAVASU CITY, AZ 86403 (928) 855-6544

IRIS DEVELOPMENT SERVICES, PLLC

901 N. HIGHWAY 77 HILLSBORO, TX 76645

MODULAR BUILDINGS:

CXT INCORPORATED

901 N. HIGHWAY 77 HILLSBORO, TX 76645

GENERAL NOTES

VERIFY ALL DIMENSIONS WITH ARCHITECT PRIOR TO CONSTRUCTION AND REPORT ANY DISCREPANCIES TO THE OWNER. ALL CONSTRUCTION SHALL CONFORM TO ALL LOCAL, STATE, & FEDERAL CODES AND REGULATIONS.

ALL SPECIFICATIONS, DIMENSIONS, AND NOTES SHALL HAVE PRECEDENCE OVER SCALE.

NOTES AND DETAILS ON DRAWINGS SHALL TAKE PRECEDENCE OVER GENERAL NOTES.

WHERE THERE MAY BE A CONFLICT IN THE SPECIFICATIONS AND/OR DRAWINGS THEN THE MORE EXPENSIVE LABOR, MATERIALS, AND

CONTRACTOR IS REQUIRED TO ABIDE BY THE LATEST EDITION OF THE AMERICAN INSTITUTE OF ARCHITECTS GENERAL CONDITIONS AND

THE STARTING OF WORK BY ANY SUBCONTRACTORS SHALL BE CONSIDERED EVIDENCE THAT HE HAS INSPECTED AND ACCEPTED ALL

ALL COMPONENTS, EQUIPMENT, ETC., SHALL BE INSTALLED PER THE MANUFACTURERS REQUIREMENTS AND PRINTED RECOMMENDATIONS.

THIS BUILDING IS TO BE CONSTRUCTED ACCORDING TO ALL INDUSTRY STANDARDS

ALL EXPOSED SURFACES NOT FACTORY PREFINISHED SHALL BE PAINTED

UNLESS OTHERWISE NOTED ALL WEATHER EXPOSED SURFACES SHALL HAVE A WEATHER RESISTIVE BARRIER TO PROTECT THE INTERIOR

ALL GYPSUM BOARD SHALL BE TAPED PER THE GYPSUM CONSTRUCTION HANDBOOK AND FASTENED PER THE MANUFACTURERS REQUIREMENTS UNLESS THE STRUCTURAL ENGINEER REQUIRES OTHERWISE OR IF THE FIRE RATED ASSEMBLY REQUIRES OTHERWI

DEFERRED SUBMITTALS:

DEFERRED SUBMITTALS: (PER 2018 IBC SECTION 106.3.4.2)

FOR THE PURPOSES OF THIS SECTION, DEFERRED SUBMITTALS ARE DEFINED AS THOSE PORTIONS OF THE DESIGN WHICH ARE NOT SUBMITTED AT THE TIME OF THE APPLICATION AND WHICH ARE TO BE SUBMITTED TO THE BUILDING OFFICIAL WITH A SPECIFIED PERIOD. DEFERRAL OF ANY SUBMITTAL ITEMS SHALL HAVE PRIOR APPROVAL OF THE BUILDING OFFICIAL. THE ARCHITECT OR ENGINEER OF THE RECORD SHALL LIST THE DEFERRED SUBMITTALS ON THE PLANS AND SHALL SUBMIT THE DEFERRED SUBMITTAL DOCUMENTS FOR REVIEW B THE BUILDING OFFICIAL.

SUBMITTAL DOCUMENTS FOR DEFERRED SUBMITTAL ITEMS SHALL BE SUBMITTED TO THE ARCHITECT OR ENGINEER OF RECORD WHO SHALL REVIEW THEM AND FORWARD THEM TO THE BUILDING OFFICIAL WITH A NOTATION INDICATING THAT THE DEFERRED SUBMITTAL DOCUMENTS HAVE BEEN REVIEWED AND THAT THEY HAVE BEEN FOUND TO BE IN GENERAL CONFORMANCE WITH THE DESIGN OF THE BUILDING. THE DEFERRED SUBMITTAL ITEMS SHALL NOT BE INSTALLED UNTIL THEIR DESIGN AND SUBMITTAL DOCUMENTS HAVE BEEN APPROVED BY THE BUILDING OFFICIAL.

DEFERRED SUBMITTALS:

OWNER NAME:

JURISDICTION:

SITE INFORMATION

2251 AZ-68, BULLHEAD CITY, AZ 86429

BULLHEAD CITY

347-10-011 AND 347-10-012 PARCEL NUMBER(S):

LOT AREA: 273.3 ACRES AND 67.1 ACRES


T21N R21W SEC 30 LOTS 1,2 & 3, W2 NE4, E2 NW4, NE4 SW4, NW4 SE4 EXCEPTING THEREFROM A STRIP OF LAND LEGAL DESCRIPTION: 300'IN WIDTH LANDWARD FROM THE EXISTING BANK OF THE COLORADO RIVER, SEC 19- THE SOUTHERN 1000' OF


THE SEC CONSISTING OF A STRIP OF LAND BEG AT THE E 1/16 CO


MOHAVE COUNTY AND UNITED STATES OF AMERICA


EXISTING ZONING: PL - PUBLIC LANDS


DRAFTING SYMBOLS

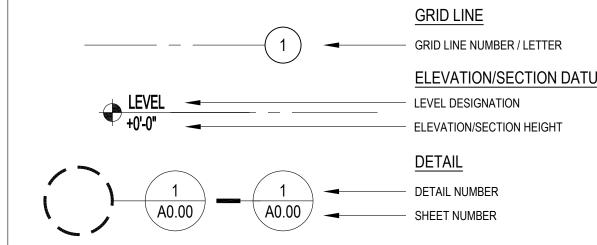


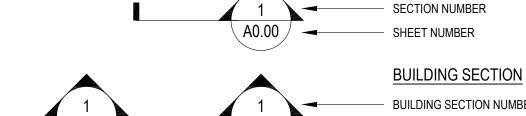


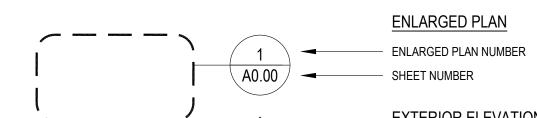

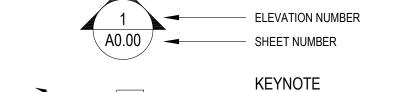


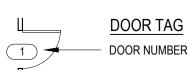


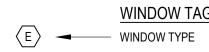


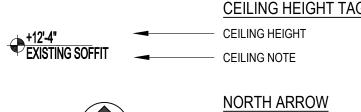



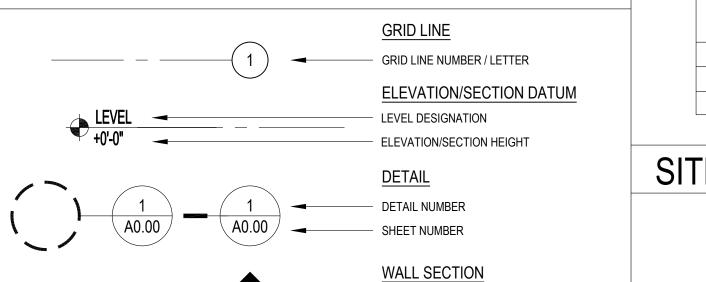


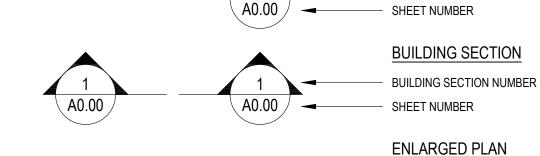

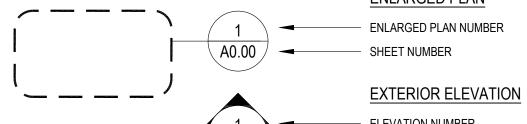





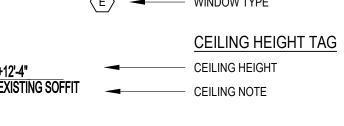



CENTER LINE

CODE ANALYSIS

PROJECT DESCRIPTION:

OF BULLHEAD CITY, ARIZONA. THE DEMOLITION WILL INCLUDE REMOVAL OF THE EXISTING RESTROOM BUILDINGS WHILE KEEPING WATER, SEWER, AND ELECTRICAL UTILITIES INTACT FOR THE INSTALLATION OF NEW MODULAR RESTROOM BUILDINGS

APPLICABLE CODES:

2018 INTERNATIONAL BUILDING CODE (IBC) w/ BULLHEAD CITY AMENDMENTS 2018 INTERNATIONAL FIRE CODE (IFC)

2018INTERNATIONAL PLUMBING CODE (IPC) 2018 INTERNATIONAL MECHANICAL CODE (IMC)

2017 NATIONAL ELECTRICAL CODE (NEC) 2009 ICC A117.1 ACCESSIBLE AND USABLE BUILDINGS AND FACILITIES (A117.1)

2010 AMERICANS WITH DISABILITIES ACT (ADA)

2018 INTERNATIONAL BUILDING CODE (IBC) w/ BULLHEAD CITY AMENDMENTS 2. OCCUPANCY CLASSIFICATION (IBC CHAPTER 3)

3. CONSTRUCTION TYPE (IBC CHAPTER 6)

4. FIRE SPRINKLERS:

5. FIRE ALARM:

6. BUILDING HEIGHTS AND ALLOWABLE AREAS (IBC TABLE 503):

ALLOWABLE AREA BASED ON CONSTRUCTION TYPE							
BUILDING	USE GROUP	CONSTRUCTION TYPE	TYPE APEA APEA HEIGHT		ACTUAL HEIGHT (FEET/STORIES)		
AREA "A"	U	TYPE V-B	5,500 SF	520 SF	40' / 1	12'-0" / 1	
AREA "B"	U	TYPE V-B	5,500 SF	520 SF	40' / 1	12'-0" / 1	
AREA "C"	U	TYPE V-B	5,500 SF	520 SF	40' / 1	12'-0" / 1	

SITE PLAN



A1.01 SITE PLAN A2.01 ENLARGED FLOOR PLANS GENERAL NOTES AND LEGEND OVERALL SITE LAYOUT (RESTROOMS RIZONA SITE LAYOUT - ENLARGED VIEWS MODULAR BUILDING REFER TO MODULAR SHOP DRAWINGS SHEET INDEX

SHEET INDEX

SHEET TITLE

ARCHITECTURAL

A0.02 DEMOLITION SITE PLAN

VICINITY MAP

PROJECT DATA & COVER SHEET



23B14 EXHIBIT 1 - PLAN SET






ISSUE DATE

SHEET TITLE:

PROJECT DATA & COVER SHEET

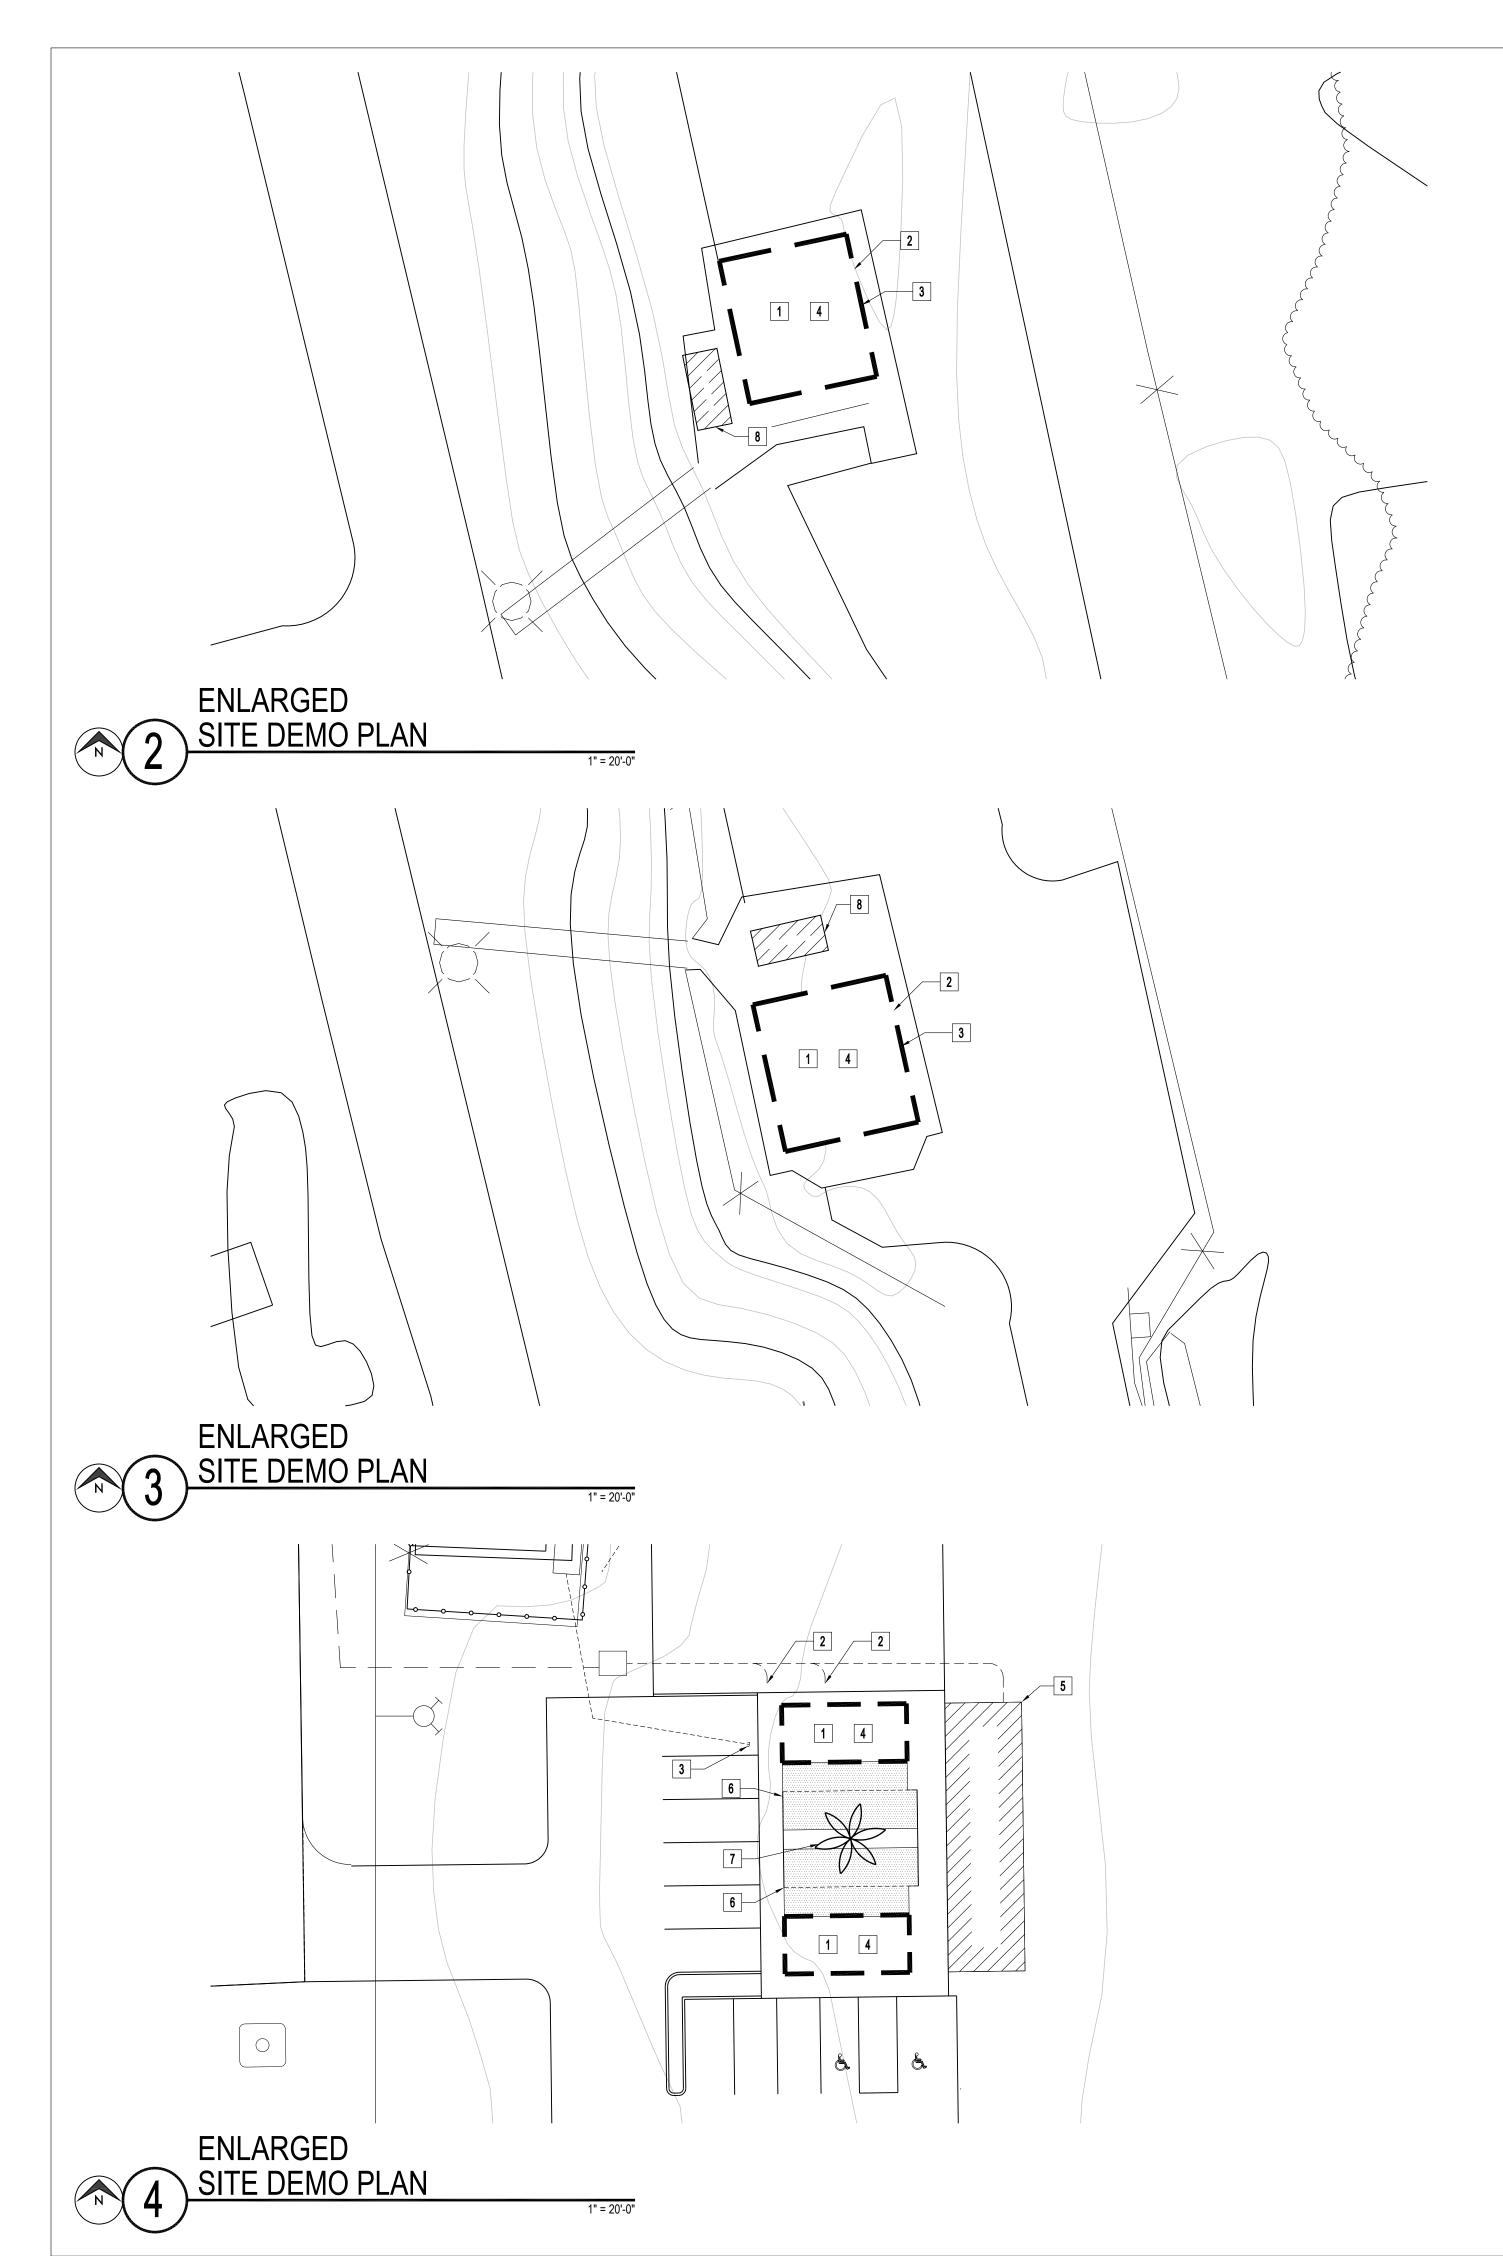

DEMOLITION NOTES

- - ALL ITEMS TO REMAIN U.N.O.
 ALL RELOCATED ITEMS AS PER OWNER.
 NEATLY CUT DEPRESSIONS, CHASES, AND THE LIKE WITH CARBORUNDUM SAWS AS REQUIRED, AND REMOVE ALL EXISTING CONSTRUCTION AS REQUIRED. FILL IN WITH MATERIALS TO MATCH EXISTING.
- CONDUCT ALL OPERATIONS WITH A MINIMUM OF NOISE. CONTRACTOR IS RESPONSIBLE TO PROMPTLY REPAIR DAMAGES TO EXISTING AND NEW FACILITIES CAUSED DURING CONSTRUCTION OPERATIONS AS DIRECTED BY CONTRACTING OFFICER AT NO COST TO
- CONTRACTOR IS RESPONSIBLE TO FIELD VERIFY ALL DIMENSIONS, SIZES, AND LOCATION OF EXISTING AND
- NEW CONSTRUCTION. • PROVIDE AND MAINTAIN SUITABLE BARRICADES, SHELTERS, LIGHTS AND DANGER SIGNALS DURING THE PROGRESS OF THE WORK. THEY SHALL MEET THE REQUIREMENTS OF STATE AND/OR LOCAL BUILDING CODES. ASSUME FULL RESPONSIBILITY OF BARRIERS TO COMPLETION OF CONTRACT AND REMOVE SAME.
- TAKE REASONABLE AND ADEQUATE PRECAUTIONS TO PROTECT THE OWNER'S PROPERTY FROM DAMAGE DURING DEMOLITION WORK, MOVING OF DEBRIS, RESTORE ANY DAMAGE TO THE OWNER'S PROPERTY DUE
- TO THE AFORE SAID WORK OR REPLACE IN A MANNER SATISFACTORY TO THE OWNER. REMOVE ALL WORK CAREFULLY AND ONLY TO THE EXTENT REQUIRED FOR THE FINAL WORK. REMOVE ALL
- LOOSE OR DAMAGED MATERIALS CAUSED BY DEMOLITION, OR NOTED, OR SPECIFIED TO BE REMOVED. ERECT DUSTPROOF PARTITION WHERE DEMOLITION WORK IS IN PROGRESS AND AS DIRECTED. SUCH PARTITIONS SHALL REMAIN IN PLACE UNTIL THEIR REMOVAL AS DIRECTED.
- CAREFULLY REMOVE ANY MATERIALS AND EQUIPMENT NOTED OR SPECIFIED TO BE REUSED OR SALVAGED AND HANDLE WITH CARE TO MINIMIZE DAMAGE. • THE USE OF PNEUMATIC OR ELECTRIC HAMMERS FOR DEMOLITION AND CUTTING PURPOSES WITHIN THE
- EXISTING BUILDING WILL NOT BE PERMITTED WITHOUT PRIOR APPROVAL OF THE OWNER.
- REMOVE ALL MATERIALS OR DEBRIS RESULTING FROM DEMOLITION OPERATIONS FROM THE SITE PROMPTLY. NO ACCUMULATION OF DEBRIS WILL BE PERMITTED.
- THE CONTRACTOR SHALL DISPOSE OF ALL DEMOLISHED OR DELETERIOUS MATERIAL, RUBBLE, DEBRIS AND WASTE OFF THE SITE, AT HIS EXPENSE. ALL TRANSPORTATION REQUIRED TO HAUL AND DISPOSE OF ALL ITEMS REQUIRED WILL BE FURNISHED BY
- AFTER THE DEMOLITION WORK IN ANY AREA IS COMPLETED, CLEAN ALL SURFACES, BEFORE ANY NEW CONSTRUCTION IS STARTED.

SITE KEYNOTES:

- EXISTING CONCRETE FLOOR SLAB TO BE REMOVED, PATCH AND REPAIR ADJACENT CONCRETE PRIOR TO CONSTRUCTION OF THE NEW BUILDING.
- EXISTING SEWER LINE TO REMAIN. CLEAN, CAP AND PREPARE IT FOR NEW BUILDING'S SEWER
- EXISTING ELECTRICAL LINE AND CONDUIT TO REMAIN. CLEAN, CAP AND PREPARE IT FOR NEW
- BUILDING'S ELECTRICAL CONNECTION. EXISTING BUILDING TO BE REMOVED.
- EXISTING BUILDING TO REMAIN.
- EXISTING PORTION OF CONCRETE SIDEWALK AND GRASS PATCH TO BE REMOVED FOR NEW BUILDING AND SIDEWALK TO BE BUILT.
- EXISTING PALM TREE TO REMAIN. EXISTING SHADE CANOPY TO REMAIN

UTILITIES & SITE COMPONENTS TO BE REMOVED SHALL BE FIELD COORDINATED & VERIFIED PRIOR TO DEMOLITION. NOTE ANY DISCREPANCIES AND REQUEST CLARIFICATION FROM ARCHITECT PRIOR TO PROCEEDING

DR MINGS AND SPECIFICATIONS REMAIN THE PROPERTY OF THE DESIGN PROFESSIONAL COPIES OF THE DRAWINGS AND SPECIFICATIONS RETAINED BY THE CLIENT MAY BE UTILIZED ONLY FOR HIS USE AND FOR OCCUPYING THE PROJECT FOR WHICH THEY WERE PREPARED, AND NOT FOR THE CONSTRUCTION OF ANY OTHER PROJECTS.

DAVIS CAMP PARK RESTROOMS
BULLHEAD CITY, ARIZONA
2251 AZ-68

ARCHITECT OF RECORD

SELBERG ASSOCIATES

ARCHITECTURE &

PLANNING

ISSUE DATE


REVISION

SHEET TITLE:

DEMOLITION SITE PLAN

SHEET NO.

A0.02

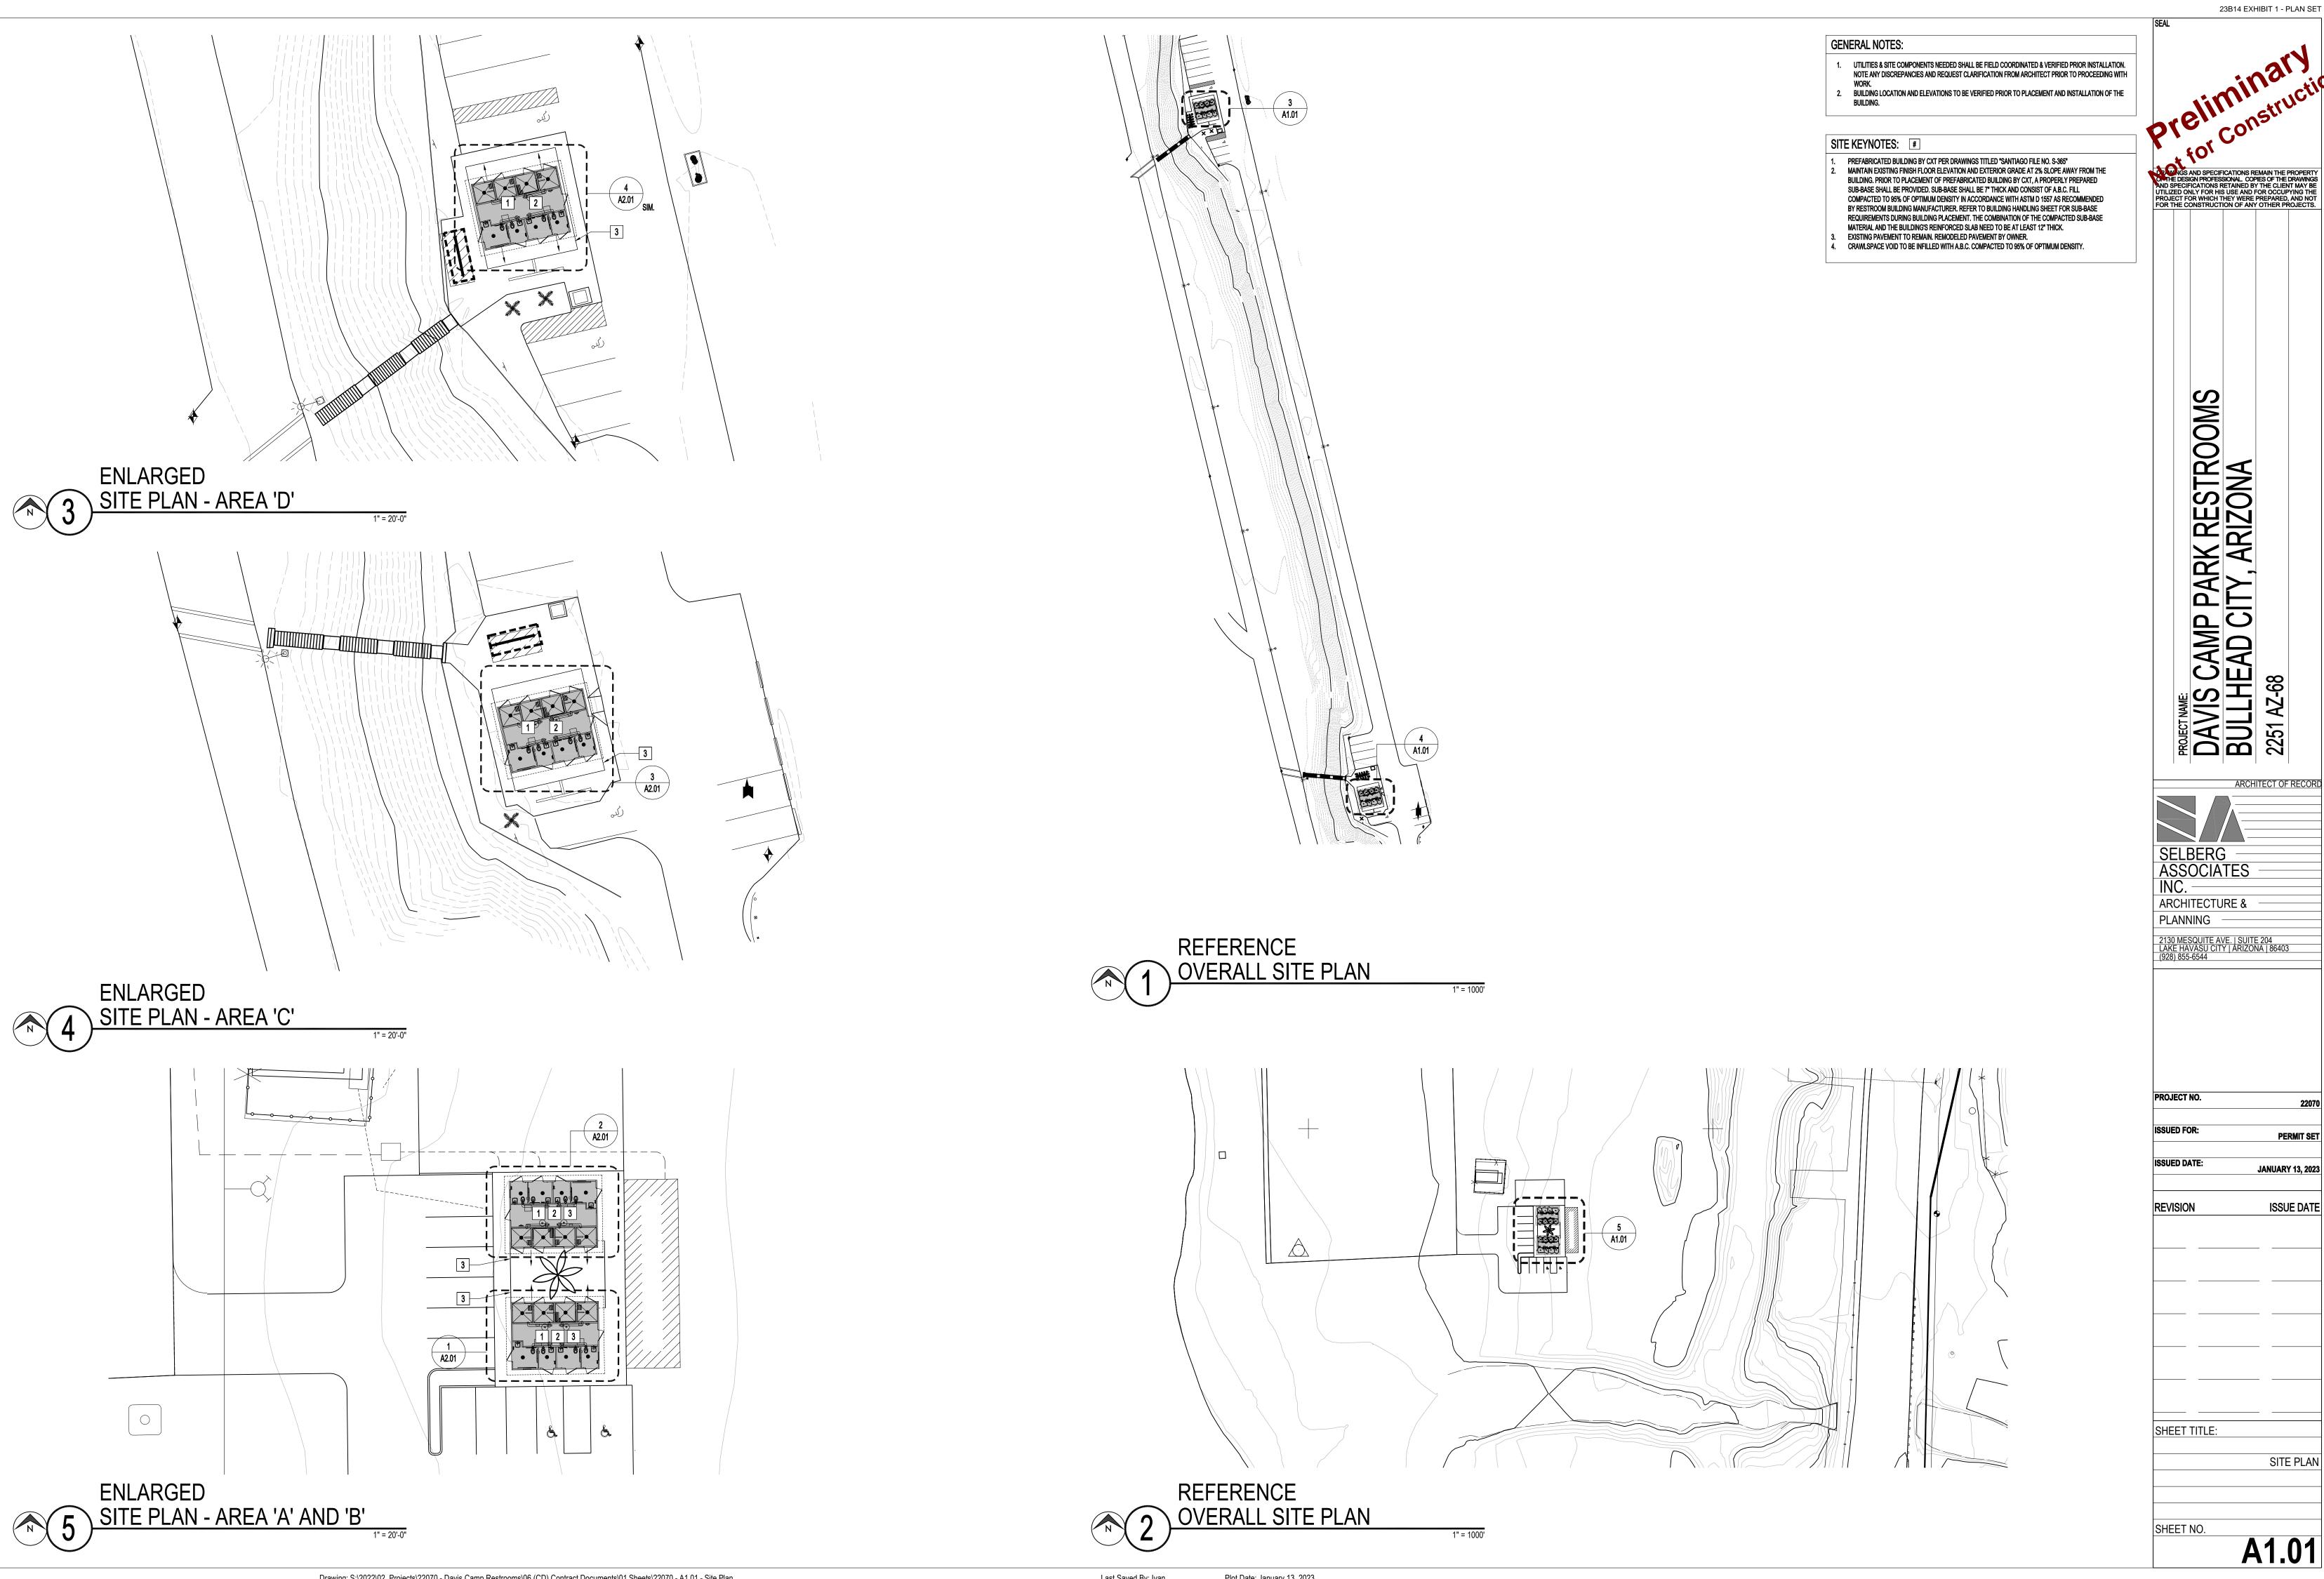


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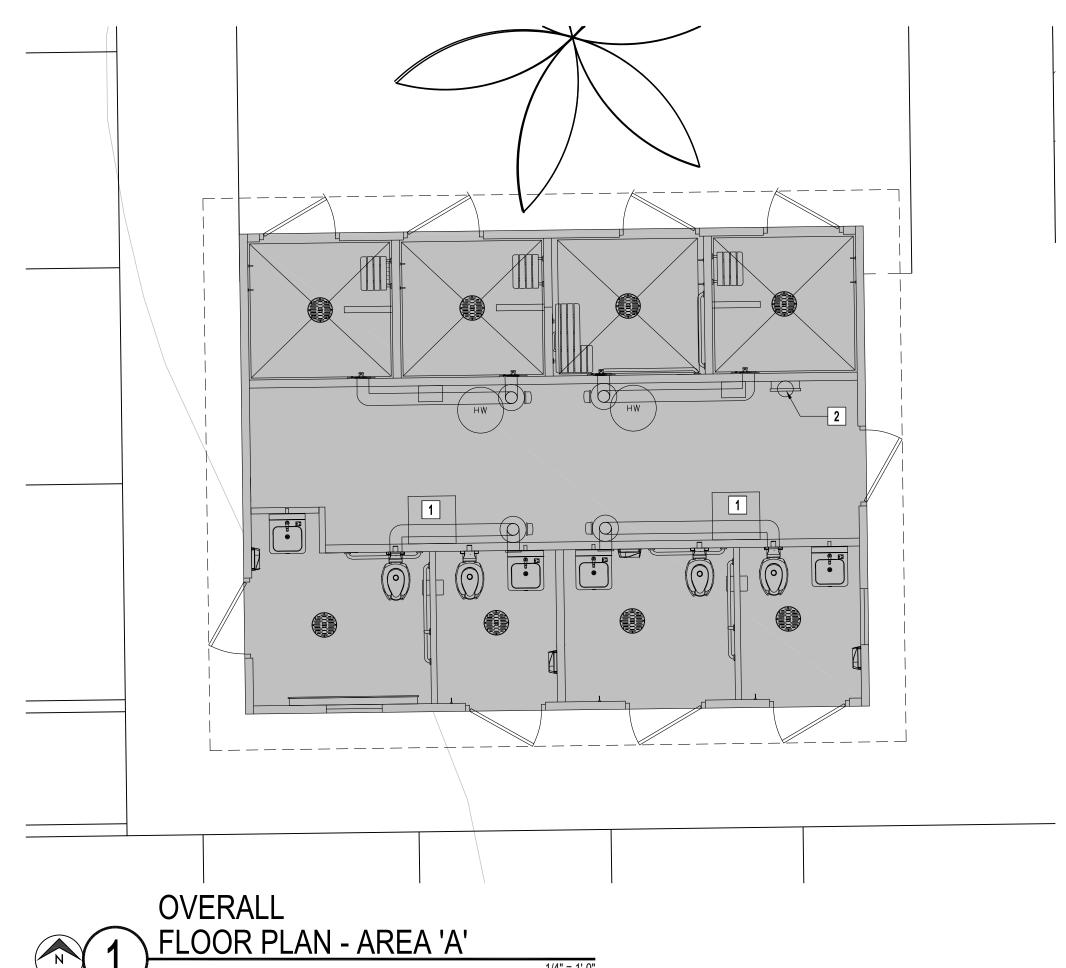
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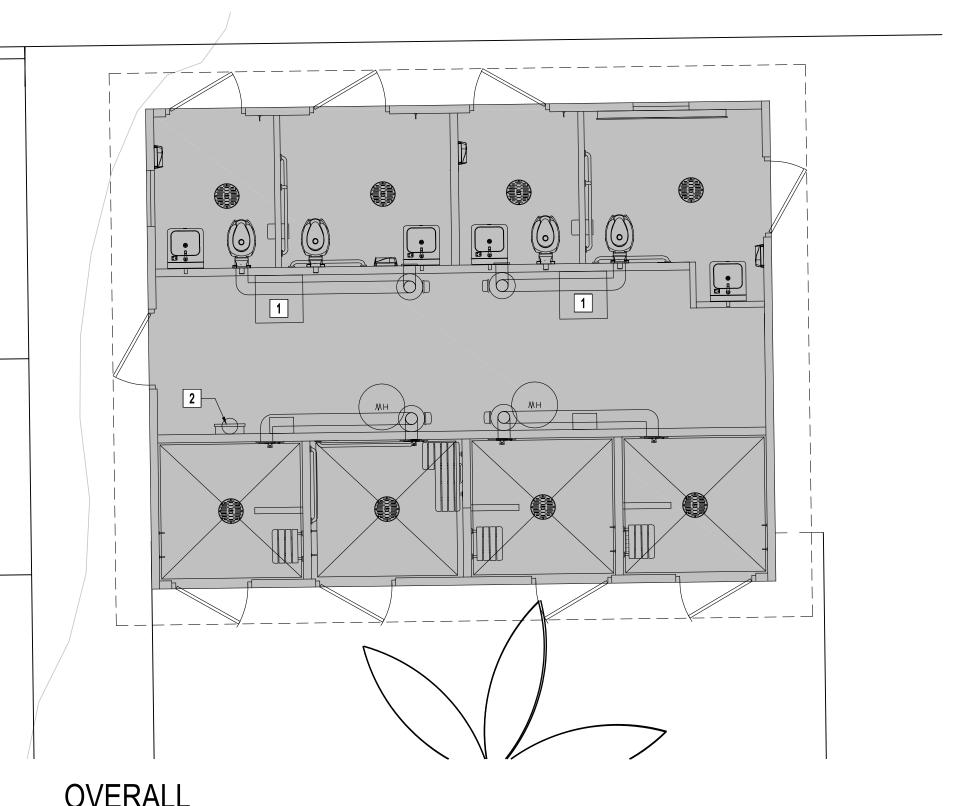
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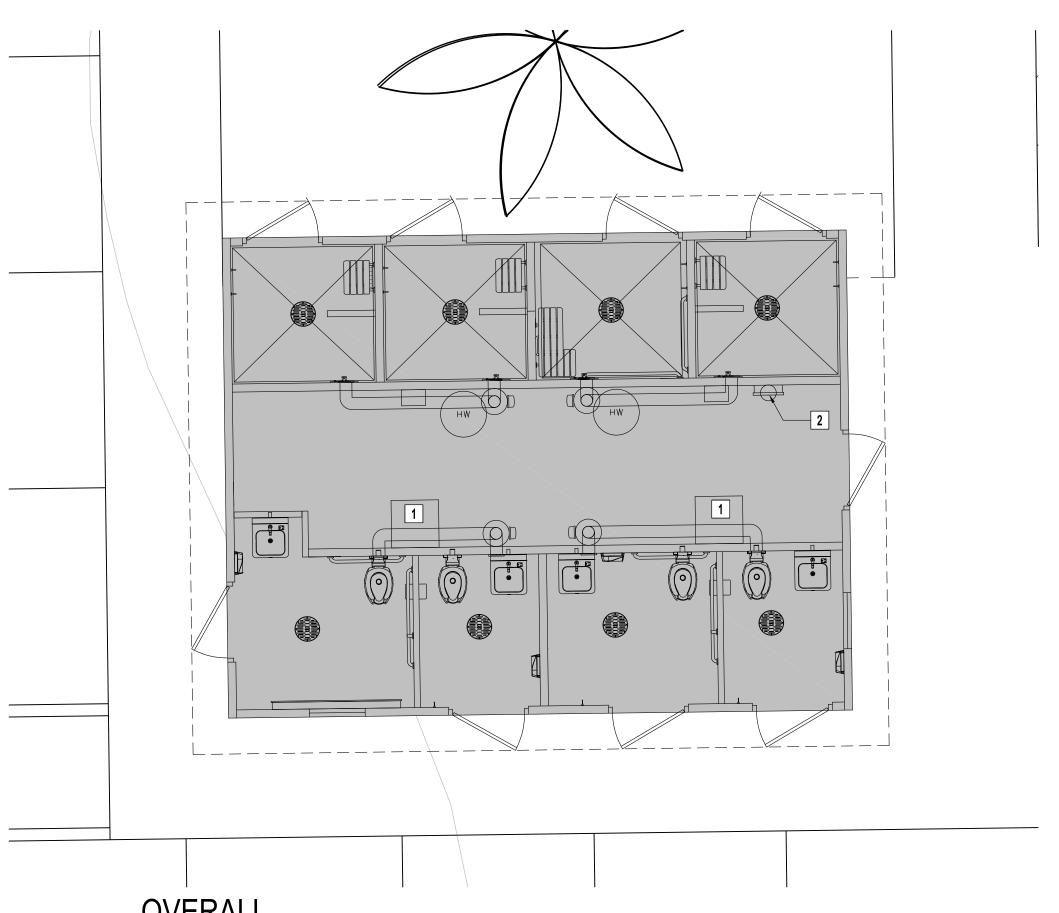
SITE PLAN

A1.01







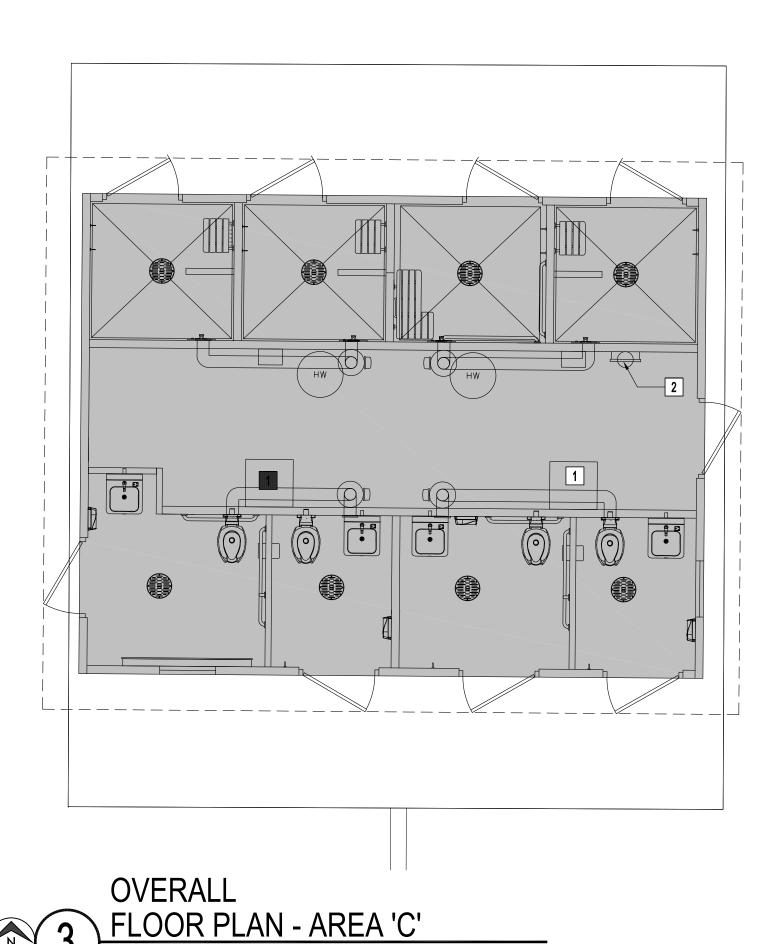

GENERAL NOTES:

 UTILITIES & SITE COMPONENTS NEEDED SHALL BE FIELD COORDINATED & VERIFIED PRIOR INSTALLATION. NOTE ANY

DISCREPANCIES AND REQUEST CLARIFICATION FROM ARCHITECT PRIOR TO PROCEEDING WITH WORK. BUILDING LOCATION AND ELEVATIONS TO BE VERIFIED PRIOR TO PLACEMENT AND INSTALLATION OF THE BUILDING.

ALL PLUMBING FIXTURES, ELECTRICAL FIXTURES, AND MECHANICAL EQUIPMENT PER CXT PER DRAWINGS TITLED "SANTIAGO FILE NO. BEFORE SUBMITTING BID, THE PLUMBING CONTRACTOR SHALL REVIEW WITH THE OWNER TO INCLUDE IN HIS BID AN AMOUNT, IF

NEEDED, TO FURNISH AND INSTALL ANY FIXTURES IN ADDITION TO FIXTURES SHOWN ON THE PLUMBING DRAWINGS. CONTRACTOR SHALL VERIFY INVERT ELEVATIONS OF SEWER TO WHICH NEW WASTE LINES ARE TO BE CONNECTED BEFORE MAKING UP OR INSTALLATION OF NEW WASTE SYSTEM. CONTRACTOR SHALL VERIFY AND COORDINATE LOCATION OF ALL

PLUMBING/SEWER LINES AND ELECTRICAL SERVICES. CONTRACTOR SHALL NOT CUT HOLES IN STRUCTURAL MEMBERS

WITHOUT FIRST SECURING WRITTEN APPROVAL FROM THE ASSUMED WATER PRESSURE - CONTRACTOR SHALL VERIFY ACTUAL WATER PRESSURE PRIOR TO CONSTRUCTION. IF PRESSURE IS LESS THAN 50 PSI CONTRACTOR SHALL CONTACT THE MOHAVE COUNTY FOR PIPE SIZING EVALUATION. IF PRESSURE EXCEEDS 80 PSI, A PRESSURE REDUCING VALVE SHALL BE

PROVIDED PIPING VELOCITY SHALL NOT EXCEED 8 FEET PER EXTEND, IF POSSIBLE, THE NEW CW TO 5'-0" BEYOND THE BUILDING EXTERIOR. FIELD COORDINATION FOR CONNECTION TO THE EXISTING WATER METER, OR VERIFY W/ OWNER IF NEW WATER METER WILL BE NEEDED (BY OTHERS). FIELD VERIFY THE EXISTING WATER LINE AND MAKE NEEDED ADJUSTMENTS FOR ITS CORRECT

EXTEND, IF POSSIBLE, NEW WASTE TO 5'-0" BEYOND BUILDING EXTERIOR. FIELD VERIFY THE EXISTING SEWER LINE AND INVERT ELEVATIONS AND MAKE NEEDED ADJUSTMENTS FOR ITS CORRECT

CONNECT ALL NEW ELECTRICAL LINE TO THE EXISTING ELECTRICAL, OR VERIFY W/ OWNER IF NEW ELECTRICAL GEAR WILL BE NEEDED (BY OTHERS).

WHERE NOT SPECIFIED FEEDERS SHALL BE COPPER. NEW FEEDERS SHALL RUN BELOW GRADE OR IN CEILING SPACE/BUILDING ROOF STRUCTURE. FEEDERS SHALL NOT RUN EXPOSED TO DIRECT SUN LIGHT - EXCEPTION: HVAC FEEDERS 10'-0"

SCHEDULE 40 PVC NON-METALLIC CONDUIT MAY BE USED BURIED IN EARTH MINIMUM 24" BELOW GRADE. ALL CONDUIT EXTENDED UNDER DRIVEWAYS OR AREAS OF VEHICULAR USAGE SHALL BE GALVANIZED HEAVY WALL STEEL CONDUIT OR SCHEDULE 40 PVC NON-METALLIC CONDUIT, MINIMUM 30" BELOW GRADE. STEEL CONDUIT INSTALLED UNDERGROUND CONDUITS SHALL NOT BE LESS THAT 24". PVC ELECTRICAL CONDUIT, UL LISTED MAY BE USED FOR UNDERGROUND SECTIONS OF LIGHTING CIRCUITS AND FEEDER RACEWAYS, ALL NON-METALLIC CONDUITS SHALL HAVE BOND WIRES, EXCEPT WHEN FEEDING SERVICES. CONDUIT RUN - PER NEC 350.26 THERE SHALL NOT BE MORE THAN

THE EQUIVALENT OF FOUR QUARTER BENDS (360 DEGREES TOTAL) BETWEEN PULL POINTS. PROVIDE PULLBOX AS NEEDED. VERIFY ELECTRICAL CONNECTION FROM THE EXISTING TRANSFORMER AND MAKE THE NEEDED ADJUSTMENTS FOR THE CORRECT FUNCTION OF THE ELECTRICAL INSTALLATION.

FLOOR PLAN KEYNOTES:

ALL SEWER AND WATER INSTALLATION TO BE CONNECTED IN THE BLOCK-OUT BUILT IN THE BUILDING. THESE CONNECTIONS NEEDS FIELD COORDINATION. REFER TO CXT DRAWINGS TITLED "SANTIAGO FILE NO. S-365" ELECTRICAL SERVICE PANEL TO BE CONNECTED TO THE EXISTING MAIN ELECTRICAL LINE. THESE CONNECTIONS NEED FIELD

COORDINATION. REFER TO CXT DRAWINGS TITLED "SANTIAGO FILE

DE WIGS AND SPECIFICATIONS REMAIN THE PROPERTY COTHE DESIGN PROFESSIONAL. COPIES OF THE DRAWINGS AND SPECIFICATIONS RETAINED BY THE CLIENT MAY BE UTILIZED ONLY FOR HIS USE AND FOR OCCUPYING THE PROJECT FOR WHICH THEY WERE PREPARED, AND NOT FOR THE CONSTRUCTION OF ANY OTHER PROJECTS.

DAVIS CAMP PAF BULLHEAD CITY, 2251 AZ-68

STROOMS

ARCHITECT OF RECORD SELBERG ASSOCIATES ARCHITECTURE & PLANNING 2130 MESQUITE AVE. | SUITE 204 LAKE HAVASU CITY | ARIZONA | 86403 (928) 855-6544

JANUARY 13, 2023 ISSUE DATE REVISION


SHEET TITLE:

SHEET NO.

ENLARGED FLOOR PLANS

A2.01

OVERALL FLOOR PLAN - AREA 'B'

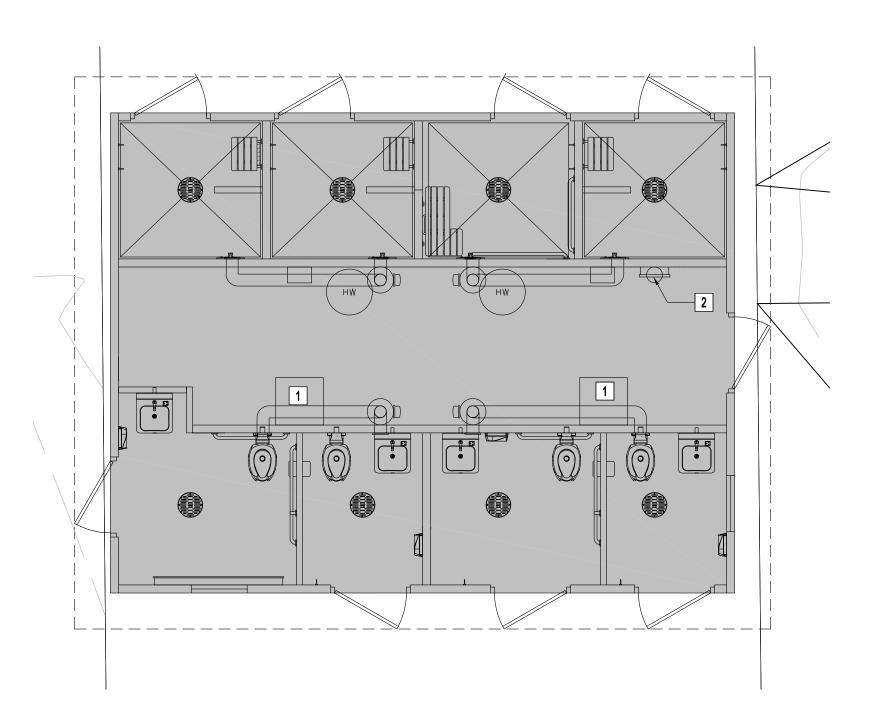

SHOWER SECTION

SANTIAGO

PANEL MARK NO. KEY PLAN


NOTES

- 1. BUILDING IS DESIGNED TO COMPLY WITH THE 2018 INTERNATIONAL BUILDING CODE (IBC).
- DESIGN COMPLIES WITH THE PROVISIONS OF THE 2018 IBC CODE FOR THE FOLLOWING LOADS: GROUND SNOW LOAD = 250 PSF ROOF SNOW LOAD = 210 PSF FLOOR LOAD = 400 PSF IBC DESIGN SPECTRAL RESPONSE $S_S = 0.909$, $S_1 = 0.333$ SITE CLASS D RISK CATEGORY: II SEISMIC DESIGN CATEGORY: D BEARING WALL SYSTEM R = 4.0WIND - V = 150 MPH WIND - V_{ASD} = 116 MPH WIND EXPOSURE C ***BUILDING IS NOT TO BE PLACED IN A LOCATION WHERE
- 3. CONSTRUCTION TYPE: V-B OCCUPANCY: U EXTERIOR WALLS: 1-HR RATED PER IBC TABLE 720.1(2), ITEM 4-1.1 MINIMUM FIRE SEPARATION DISTANCE: 10' PER IBC TABLE 705.8 MAXIMUM UNPROTECTED OPENING AREA: 4.02% (WALL W3 & W10):

LOADS EXCEED THE VALUES PROVIDED ABOVE

- CONCRETE STRENGTH f'ci = 2500 PSI INITIAL f'c = 5000 PSI FINAL AIR ENTRAINMENT $6\% \pm 1 \, 1/2\%$ IN PLASTIC CONCRETE. REINFORCING STEEL: ASTM A615 #3 GRADE 40, #4 AND LARGER GRADE 60 Fy=60 KSI MINIMUM LAP 18" AT SPLICES. TIE BARS WITH DOUBLE ANNEALED 16 GA IRON WIRE. REINFORCING TO BE PLACED IN CENTER OF PANEL UNO. WELDED WIRE FABRIC (W.W.F.): ASTM A1064 GRADE 80, 4x4xW6.7xW6.7, Fy=80 KSI (OR EQUIVALENT), SMOOTH WIRE, MIN. LAP
- EMBEDDED ITEMS IDENTIFIED ON DRAWINGS (i.e. PS-2, R301) REFER TO CXT STANDARD EMBEDMENT CATALOG.
- BACK OF PANELS TO HAVE SMOOTH TROWEL FINISH UNO. ALL SURFACES TO BE TEXTURED ARE NOTED ON PANEL DWG'S
- REFER TO SEPARATE CXT INCORPORATED SPECIFICATIONS COVERING DESIGN, MATERIALS, PRODUCTION, AND INSTALLATION CRITERIA FOR SPECIFIC STYLE OF BUILDING.
- ALL REBAR BENDS ARE TO HAVE A MINIMUM RADIUS OF 6x THE BAR
- INSTALLATION TO MEET APPLICABLE LOCAL, STATE & FEDERAL CODES, BY OTHERS.
- ADEQUATE PLUMBING FACILITIES MUST BE PROVIDED IN ACCORDANCE WITH 2018 IBC (NOT BY CXT)
- BUILDING TO BE CLOSED DURING HOURS OF DARKNESS OR MEANS OF EGRESS LIGHTING MUST BE PROVIDED ON SITE BY OTHERS.

BACK

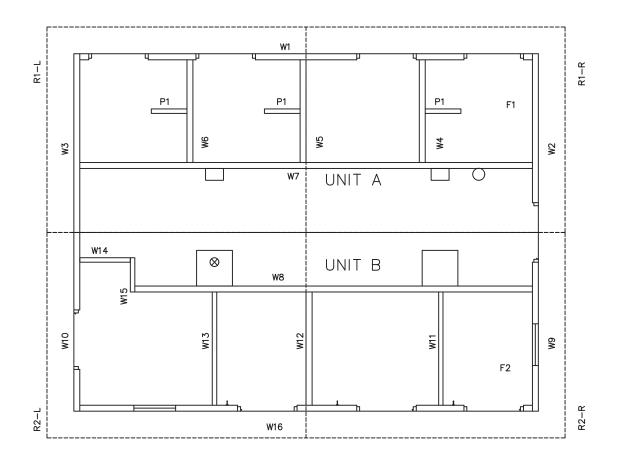

FRONT

APPLICABLE CODES

2018 INTERNATIONAL BUILDING CODE 2018 INTERNATIONAL PLUMBING CODE 2017 NATIONAL ELECTRIC CODE 2018 INTERNATIONAL MECHANICAL CODE 2018 INTERNATIONAL ENERGY CONSERVATION CODE 2009 ICC A117.1

SPECIAL CONDITIONS AND/OR LIMITATIONS

ACCESSIBILITY TO THIS BUILDING, INCLUDING PARKING IS TO BE PROVIDED BY OTHERS AND CONSTRUCTED IN ACCORDANCE WITH ALL LOCAL BUILDING CODES.

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S-03	BUILDING ELEVATIONS
S-04 S-05	BUILDING ELEVATIONS BUILDING ELEVATIONS
S-06	INTERIOR ELEVATIONS
S-07	DETAILS
S-08	WALL PANEL MARK W1
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S-22	ROOF SLAB MARK R1-R
S-23	ROOF SLAB MARK R1-L
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S-25	ROOF SLAB MARK R2-L
S-26	ROOF SLAB MARK R1-L ROOF SLAB MARK R2-R ROOF SLAB MARK R2-L INTERIOR PARTITION P1 GRAVEL PAD DETAIL
S-27	GRAVEL PAD DETAIL
S-28	FLOOR DRAIN LOCATIONS & BELOW FLOOR PIPING
S-29	PLUMBING WASTE & VENT PIPING PLAN
S-30	PLUMBING WATER PIPING PLAN & DIAGRAMS
S-31	PLUMBING DETAILS, DIAGRAMS & SCHEDULE
S-32	ELECTRICAL NOTES, LEGEND & SCHEDULE
S-33	ELECTRICAL PLAN & SCHEDULE
S-34	MATERIAL LIST
S-35	MATERIAL LIST



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SANTIAGO BUILDINGS S-365 THRU S-367

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S-01

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RALL LENGTH OR WIDTH

10 S OR UNDER = ± 1/8"

10 TO 20 S = +1/8", -3/16"

20 TO 40 S = ±1/4" TOTAL THICKNESS = -1/8, +1/4 VARIATION FROM SQUARE = ±1/8 PER 6 S OF DIAGONAL LOCAL SMOOTHNESS = 1/4" IN 10 S POSITION OF TENDONS = ±1/4" POSITION OF BLOCKOUTS = ±1/4" SIZE OF BLOCKOUTS = ±1/4° TIPPING AND FLUSHNESS OF PLATES = +1/16, -1/4 BOWING = LENGTH/360 END SQUARENESS = ±1/8"

CASTING TOLERANCES:

ARIZONA STATE P.E. DRAWINGS (ELECTRONIC), TAG, & APPROVAL

SPLIT FACE BLOCK WALL TEXTURE: WALL COLOR: BEHR DARK ASH


ROOF TEXTURE: ROOF COLOR: BEHR FASHION GRAY

TRIM & DOOR PAINT: BLACK


MARINE PACKAGE REQ'D SHOWER SECTION ONLY

2 CASES GRAFFITI REMOVER REQ'D (SHIPPED LOOSE)

- 1. THE SANTIAGO STYLE BUILDING CONSISTS OF TWO SEPARATE UNITS TO BE PLACED AND JOINED AT THE PROJECT SITE. PROPER SITE PREPARATION AND HANDLING IS ESSENTIAL FOR THE SAFE AND PROPER INSTALLATION OF THE BUILDING.
- 2. PROVIDE SHALLOW TRENCH WITH ROLLED EDGES ALONG BUILDING JOINT LINES TO PREVENT TRAPPING MATERIAL BETWEEN UNITS BEING DRAWN TOGETHER.
- 3. PLACE UNITS AS CLOSE TO ONE ANOTHER AS POSSIBLE. SPACE BETWEEN UNITS SHOULD NOT EXCEED 1" AT INITIATION OF POST-TENSIONING. MAXIMUM ALLOWABLE FINISH JOINT SPACE BETWEEN UNITS SHALL BE 1/2".
- 4. POST-TENSIONING TO DRAW UNITS INTO CONTACT SHALL BE ACCOMPLISHED WITH EQUIPMENT PROVIDED BY CXT BY PROPERLY TRAINED PERSONNEL. INSTRUCTIONS PROVIDED BY CXT SHALL BE CAREFULLY ADHERED TO. ALL NECESSARY SAFETY PRECAUTIONS SHALL BE TAKEN BY INSTALLATION PERSONNEL. STRESS TENDONS TO DRAW UNITS TOGETHER AND TO RETAIN A MINIMUM EFFECTIVE FORCE IN EACH TENDON OF 2 KIPS AFTER ALL LOSSES.
- 5. AFTER COMPLETION OF BUILDING PLACEMENT, BLOCKOUTS AT POST-TENSIONING ANCHORAGE POINTS SHALL BE FILLED WITH NON-METALLIC, NON-SHRINK GROUT. PROVIDE SMOOTH, NEAT FINISH COMPATIBLE WITH SURROUNDING CONCRETE SURFACES. MATCH CONCRETE COLOR.
- 6. PROVIDE UTILITY CONNECTIONS (PLUMBING & ELECTRICAL) AS REQUIRED AND/OR AS CALLED FOR ON THE DRAWINGS.
- 7. FILL FLOOR BLOCKOUTS AFTER COMPLETION OF UTILITY HOOKUPS WITH CONCRETE. SLOPE TO DRAIN.

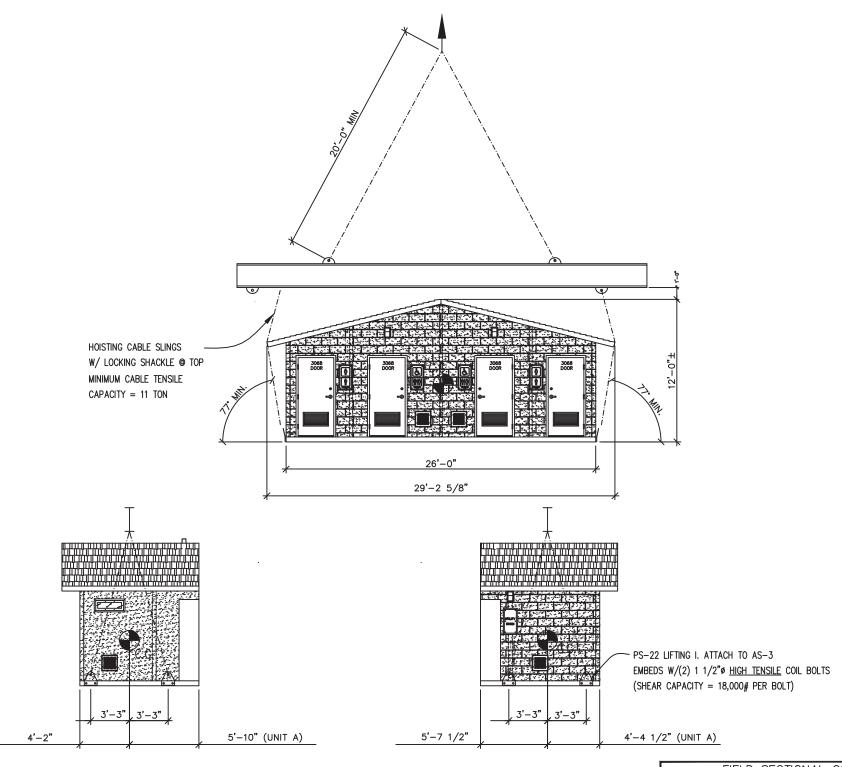

CRANE LIFTING SCHEMATIC - UNITS A & B

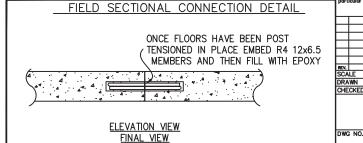

SANTIAGO


RECOMMENDED HANDLING AND INSTALLATION INSTRUCTIONS

Precast Products 6707 E. Flamingo Ave. Bldg 300, Nampa, ID 8368 901 N. Highway 77 Hillsboro, TX 76645 362 Waverly Road Williamstown, WV 26187

SANTIAGO

BUILDINGS S-365 THRU S-367


23B14 EXHIBIT 1 PLAN SET

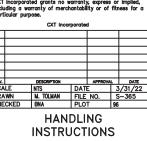



S-02


SECTION WEIGHT LENGTH HEIGHT WIDTH 29'-3" 11'-6" 12'-0" A (BACK) 75,200 29'-3" 11'-6" 12'-0" B (FRONT) 71,500


SHIPPING WEIGHTS AND DIMENSIONS

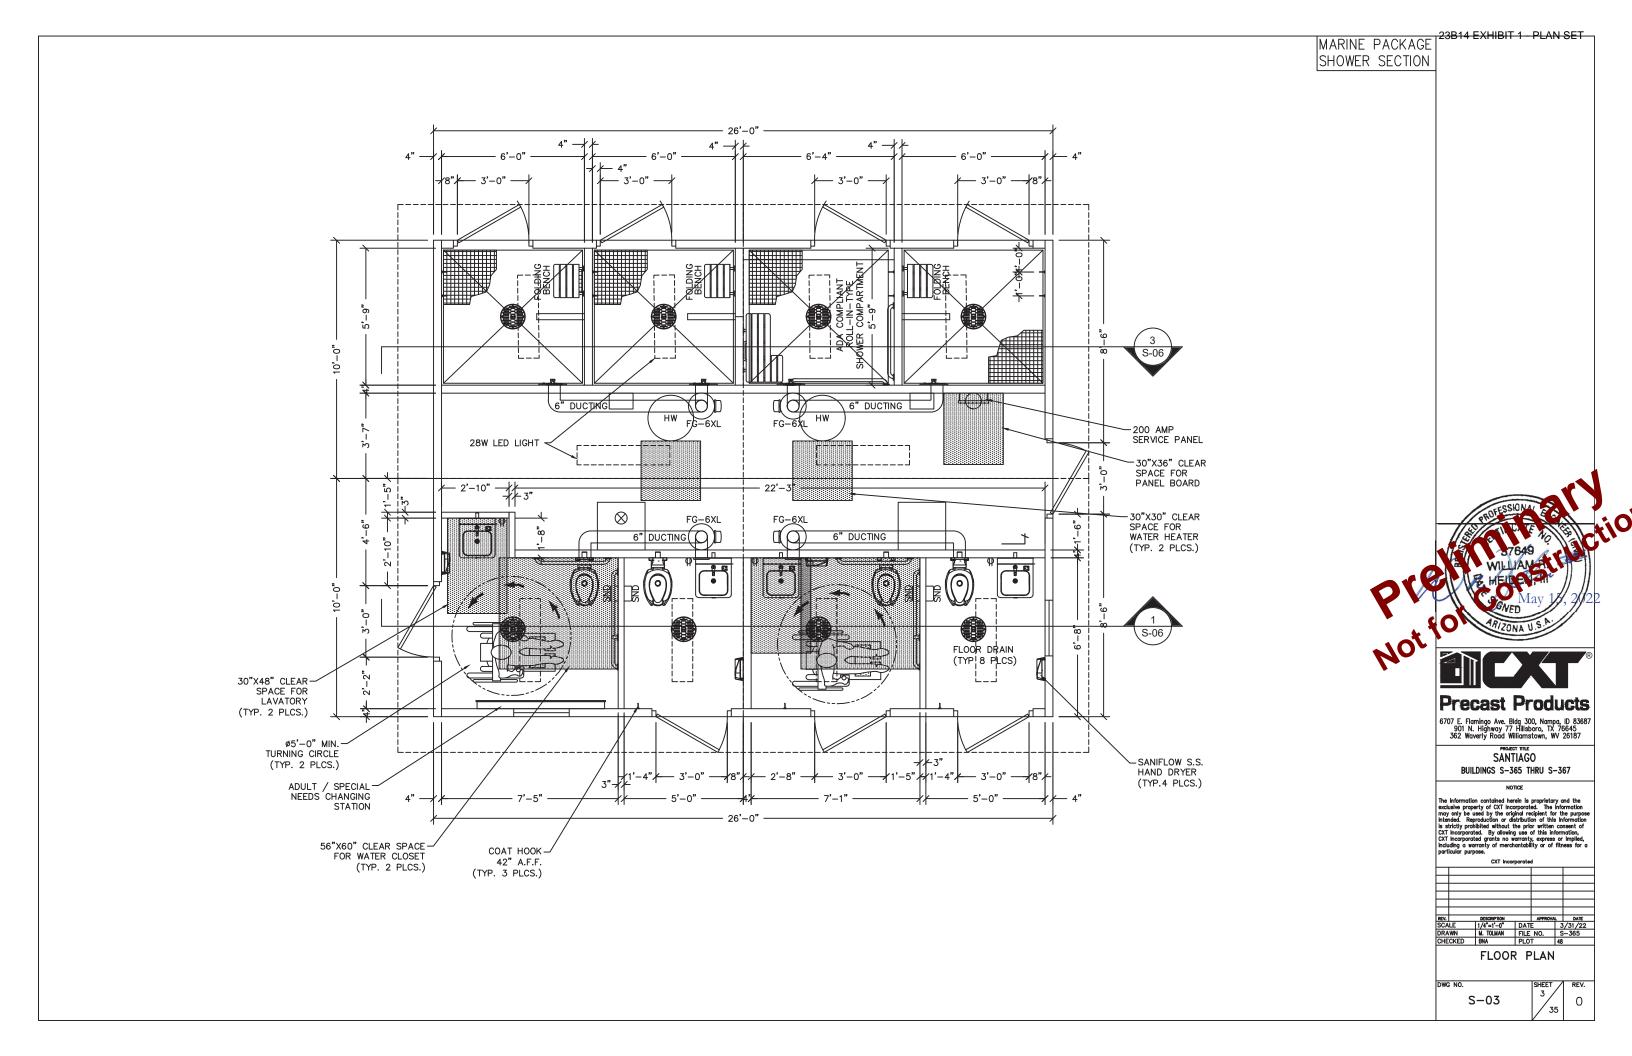


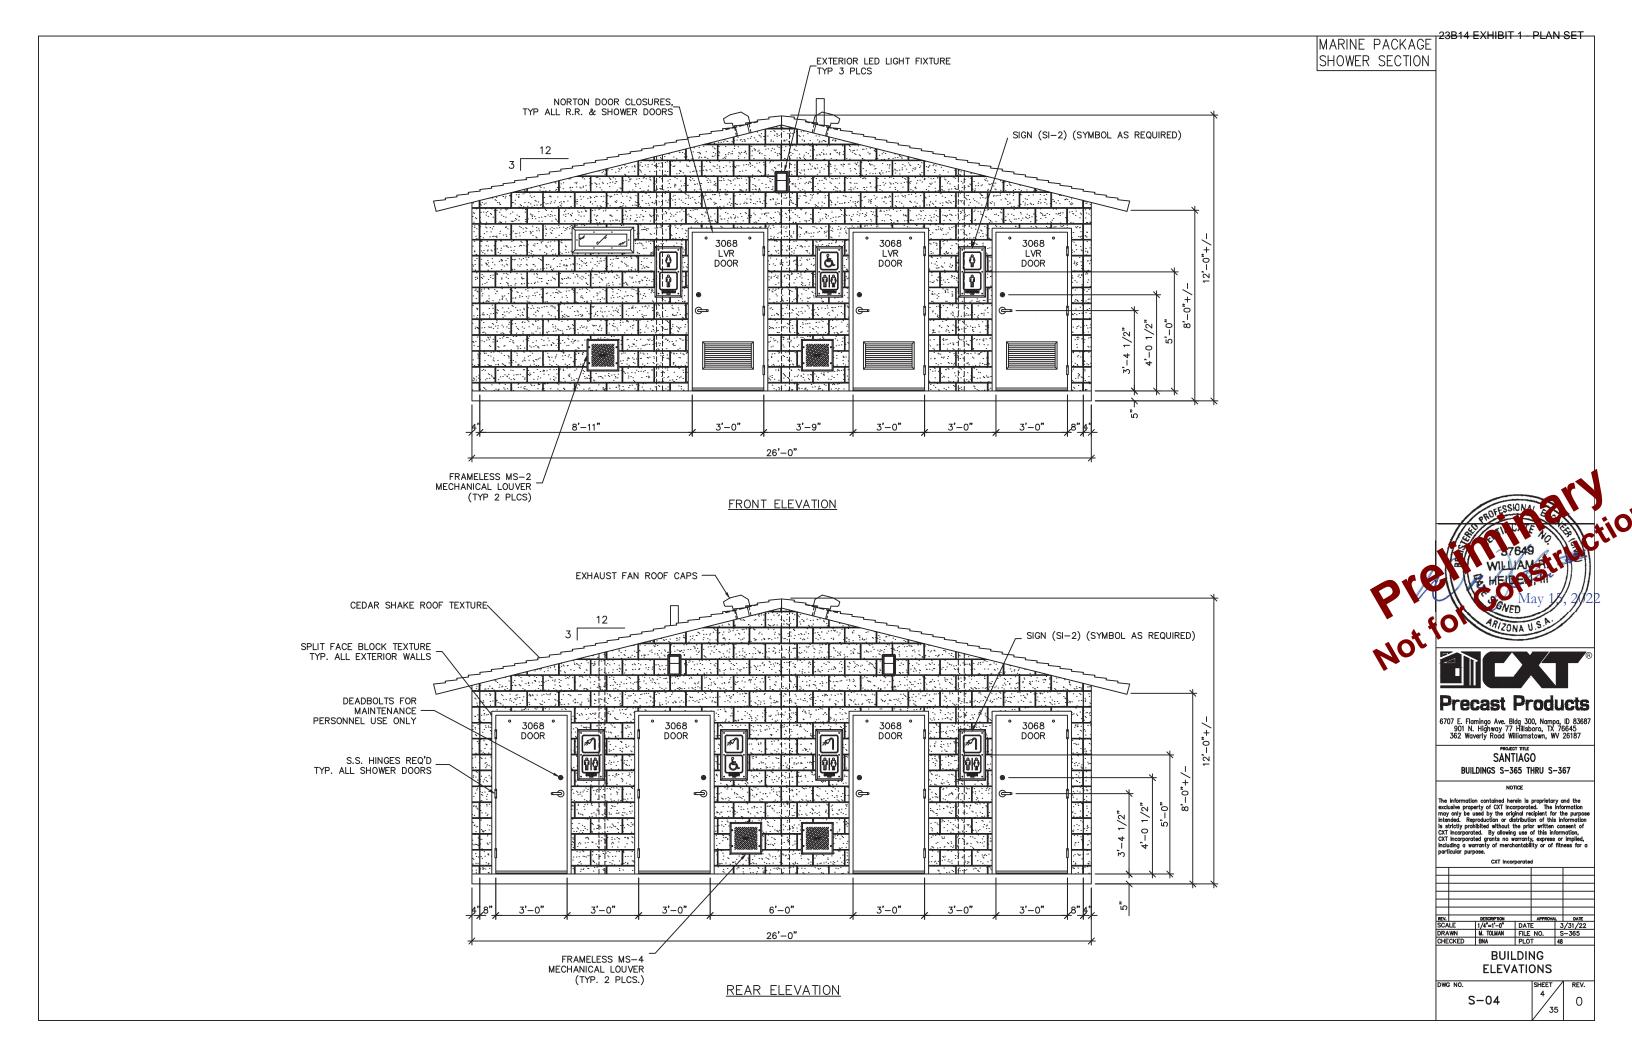


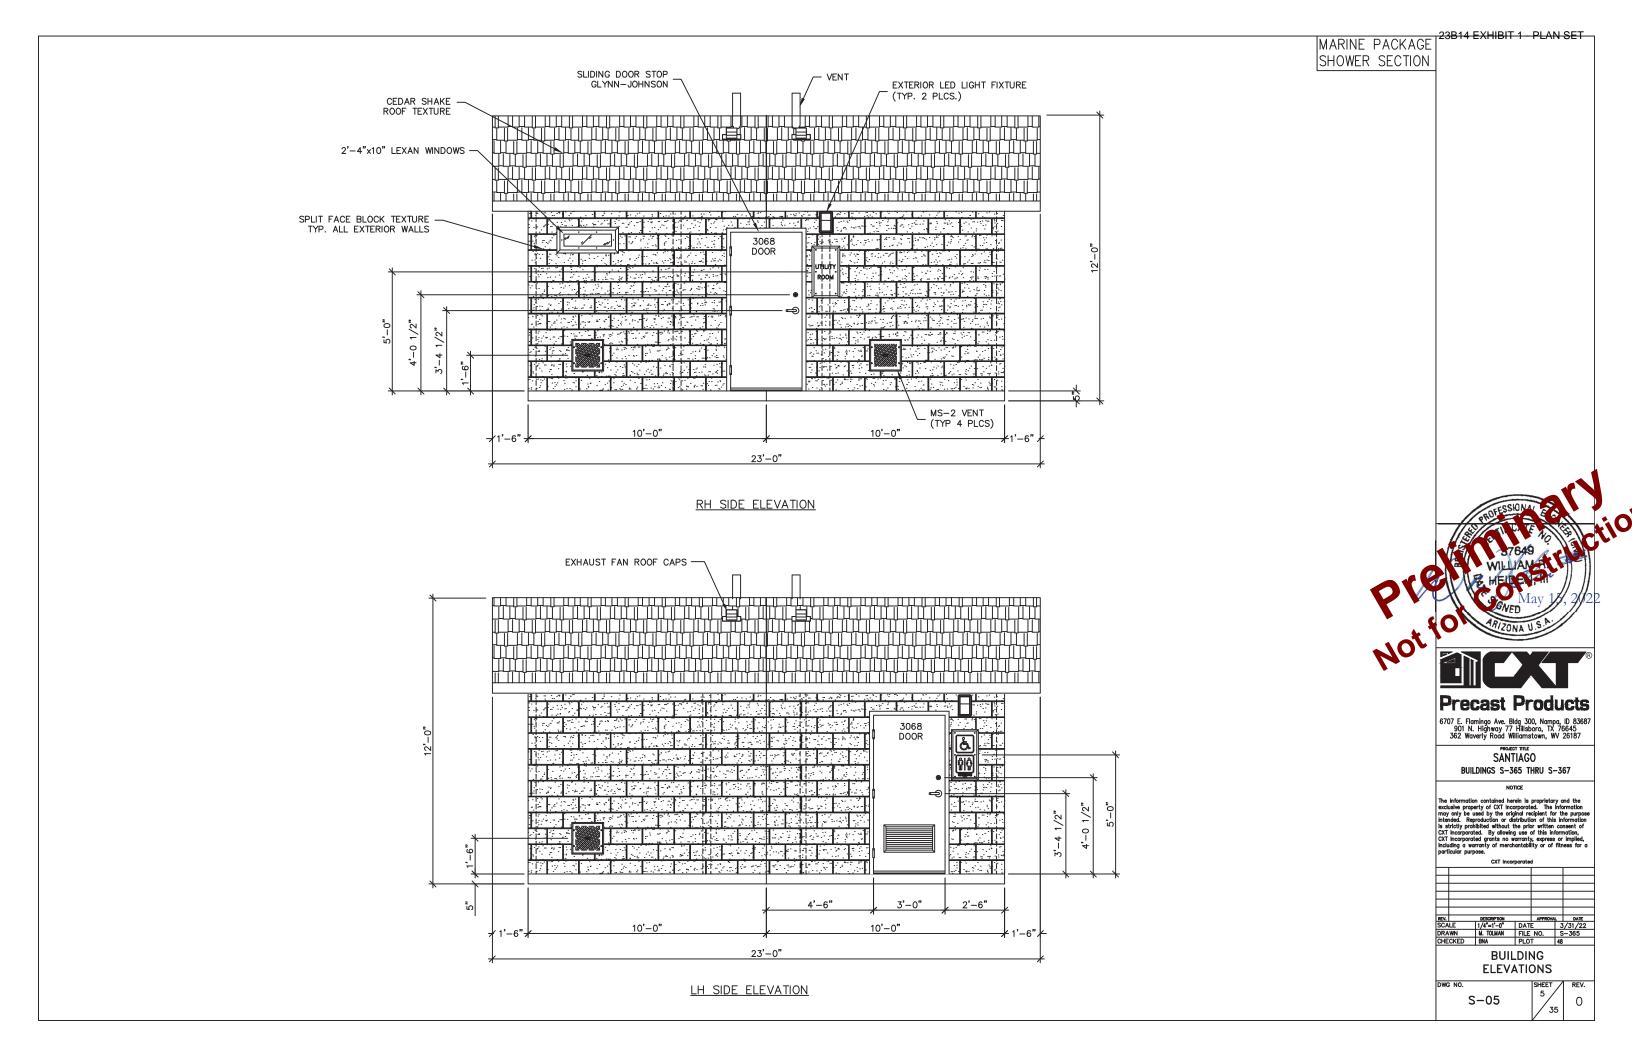

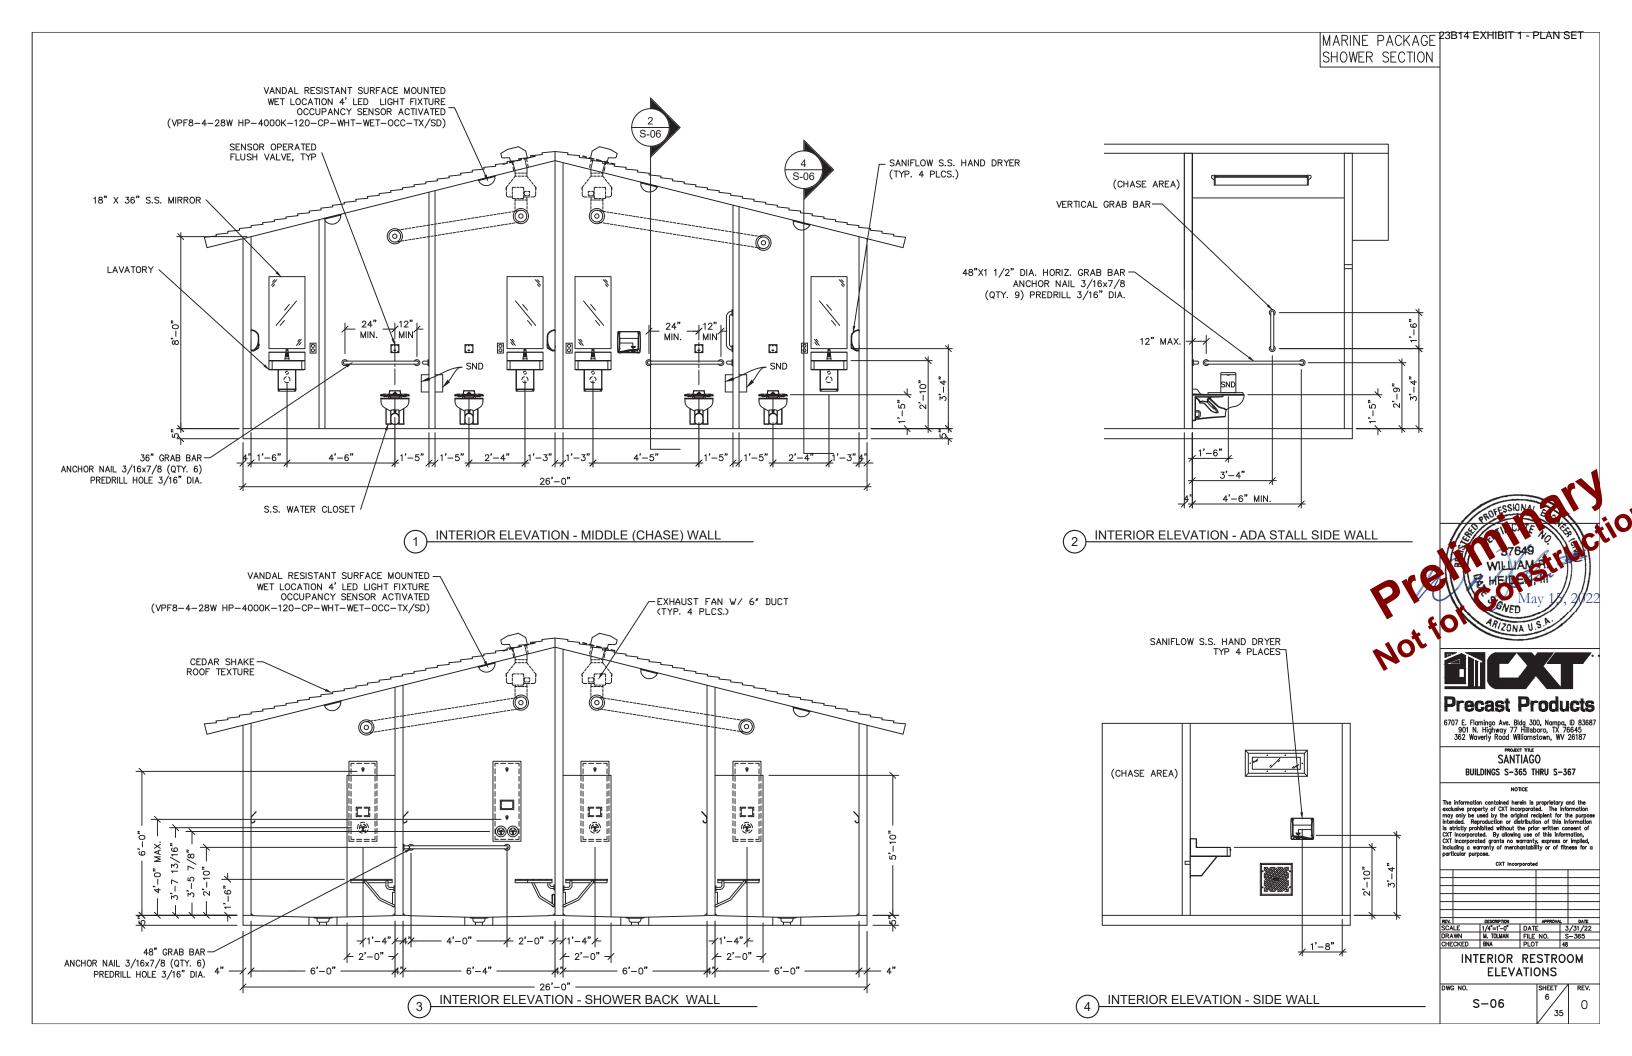

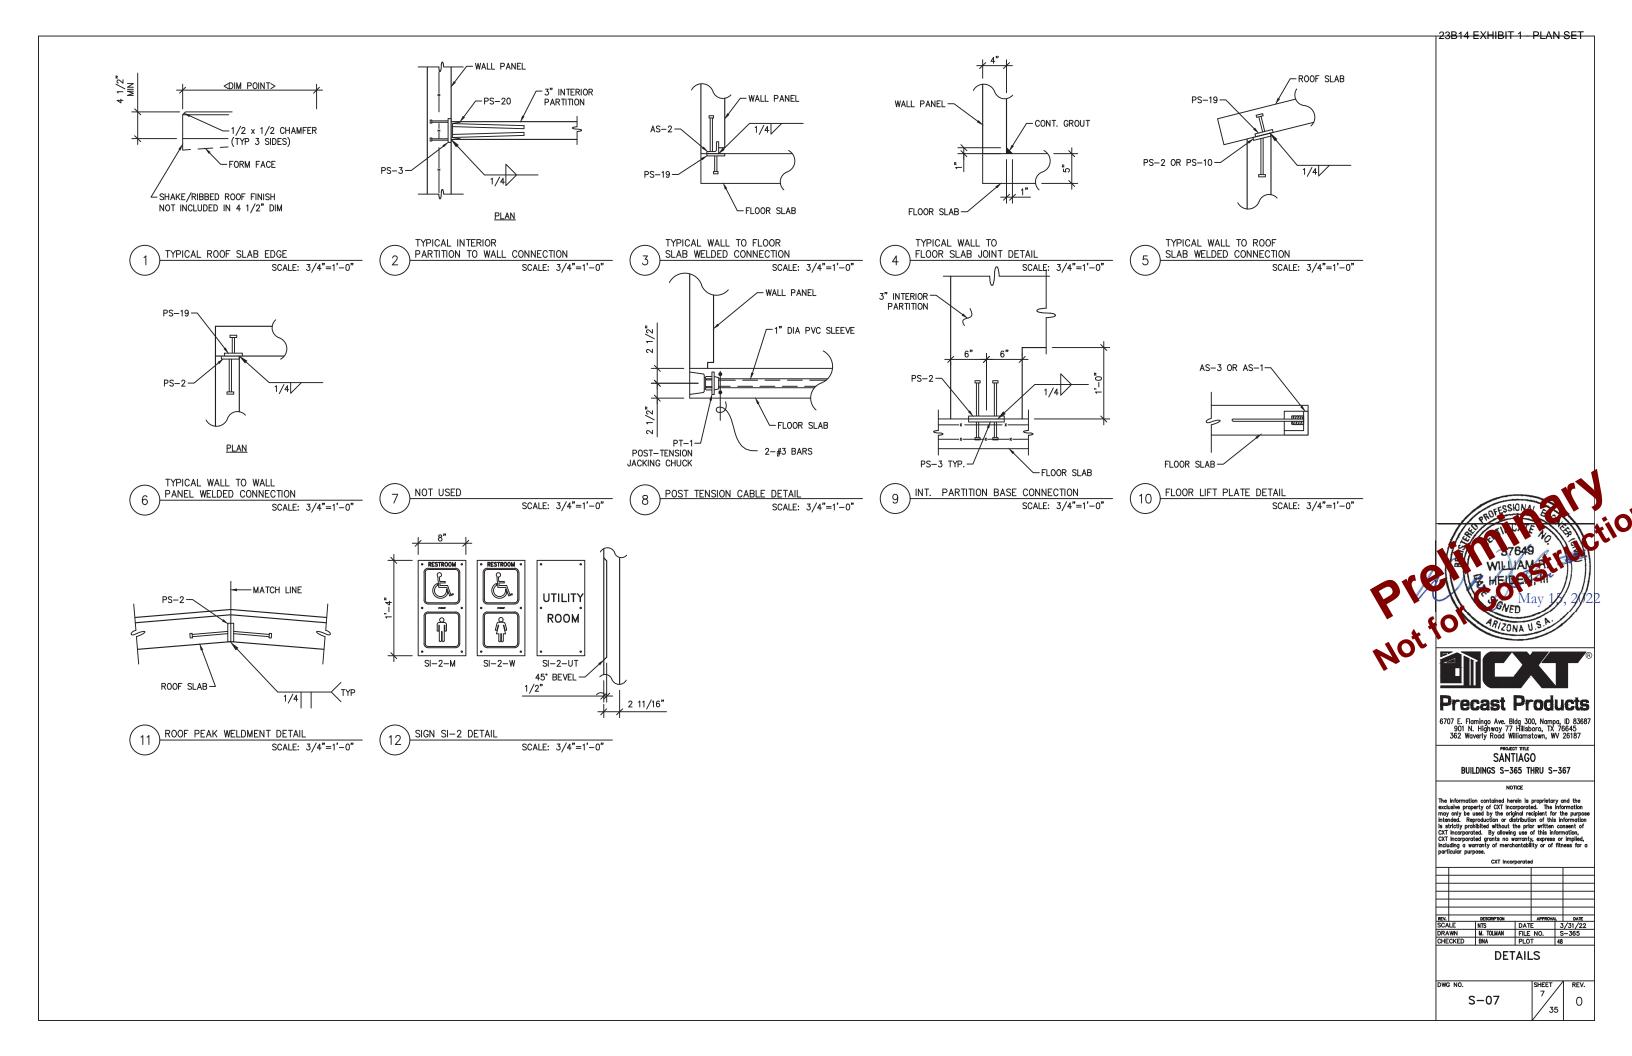

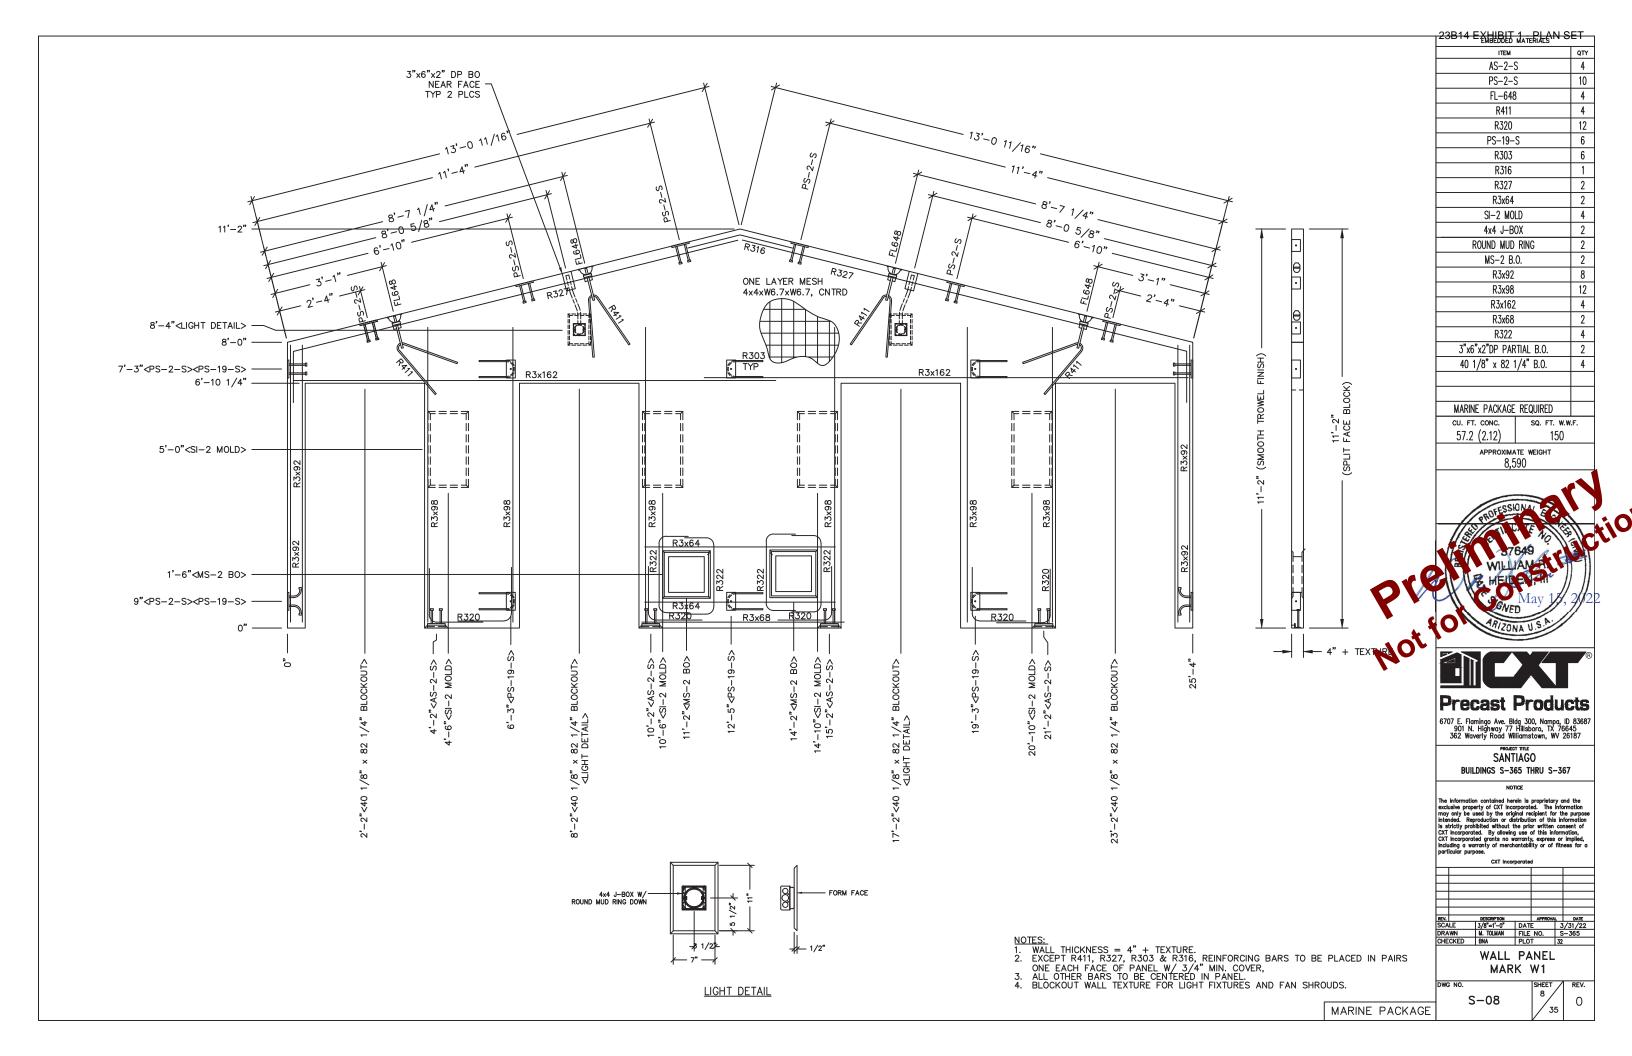

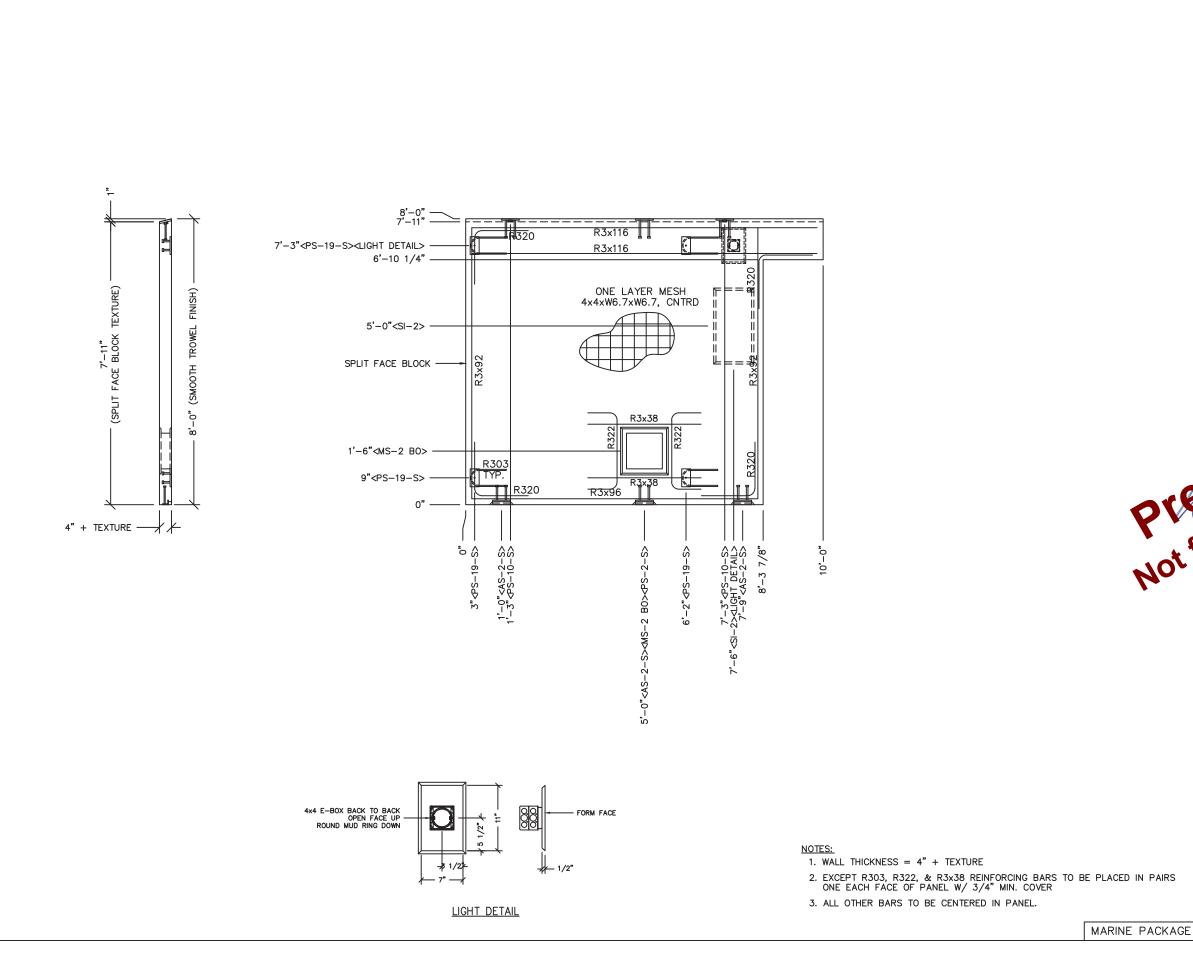

23B14 EXHIBIT 1 PLAN SET

23B14 EXHIBEDDED MATERIALS IN S	El
ITEM	QT
AS-2-S	3
PS-10-S	2
PS-19-S	4
R303	4
PS-2-S	1
R3x116	
R3x92	4
R320	8
R3x38	2
R322	2
MS-2 BLOCKOUT	2 2 1 2 1
R3x96	2
SI-2 MOLD	1
4x4 E-BOX	2
ROUND MUD RING	1
MARINE PACKAGE REQUIRED	
CU. FT. CONC. SQ. FT. W.V	v.F.
22.7 (0.84) 69	
approximate weight 3,405	
·	

OT OTTO

Precast Products

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PROJECT TITLE SANTIAGO

BUILDINGS S-365 THRU S-367

NOTICE


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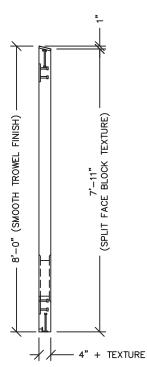
WALL PANEL MARK W2

S-09

SHEET 9 35

-09



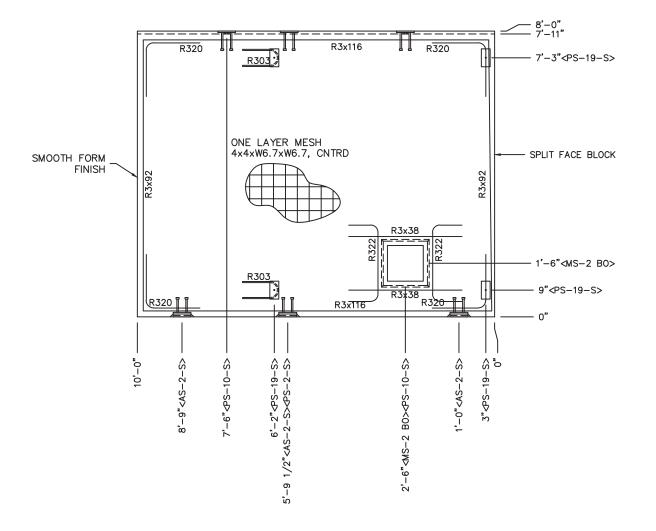

NOTES:

1. WALL THICKNESS = 4" + TEXTURE.

3. ALL OTHER BARS TO BE CENTERED IN PANEL.

AS-2-S 3 2 PS-10-S PS-19-S 4 R303 4 1 PS-2-S 4 R3x116 R3x92 4 R320 8 R3x38 2 R322 2 MS-2 BLOCKOUT 1

23B14 EXHIBIT 1 PLAN SET

MARINE PACKAGE REQUIRED CU. FT. CONC.

26.5 (0.98) approximate weight 3,975

Precast Products

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SANTIAGO BUILDINGS S-365 THRU S-367

l bar	router par	pooo.						
	CXT Incorporated							
L								
L								
_								
REV.		DESCRIPTION		APPROVA		DATE		
SCA	LE	3/8"=1'-0"	DAT	E	3	/31/22		
DRA		M. TOLMAN	FILE	NO.	S	-365		
CHE	CKED	BNA	PLO	T	32			
		34/41.1		NIEL				


WALL PANEL MARK W3


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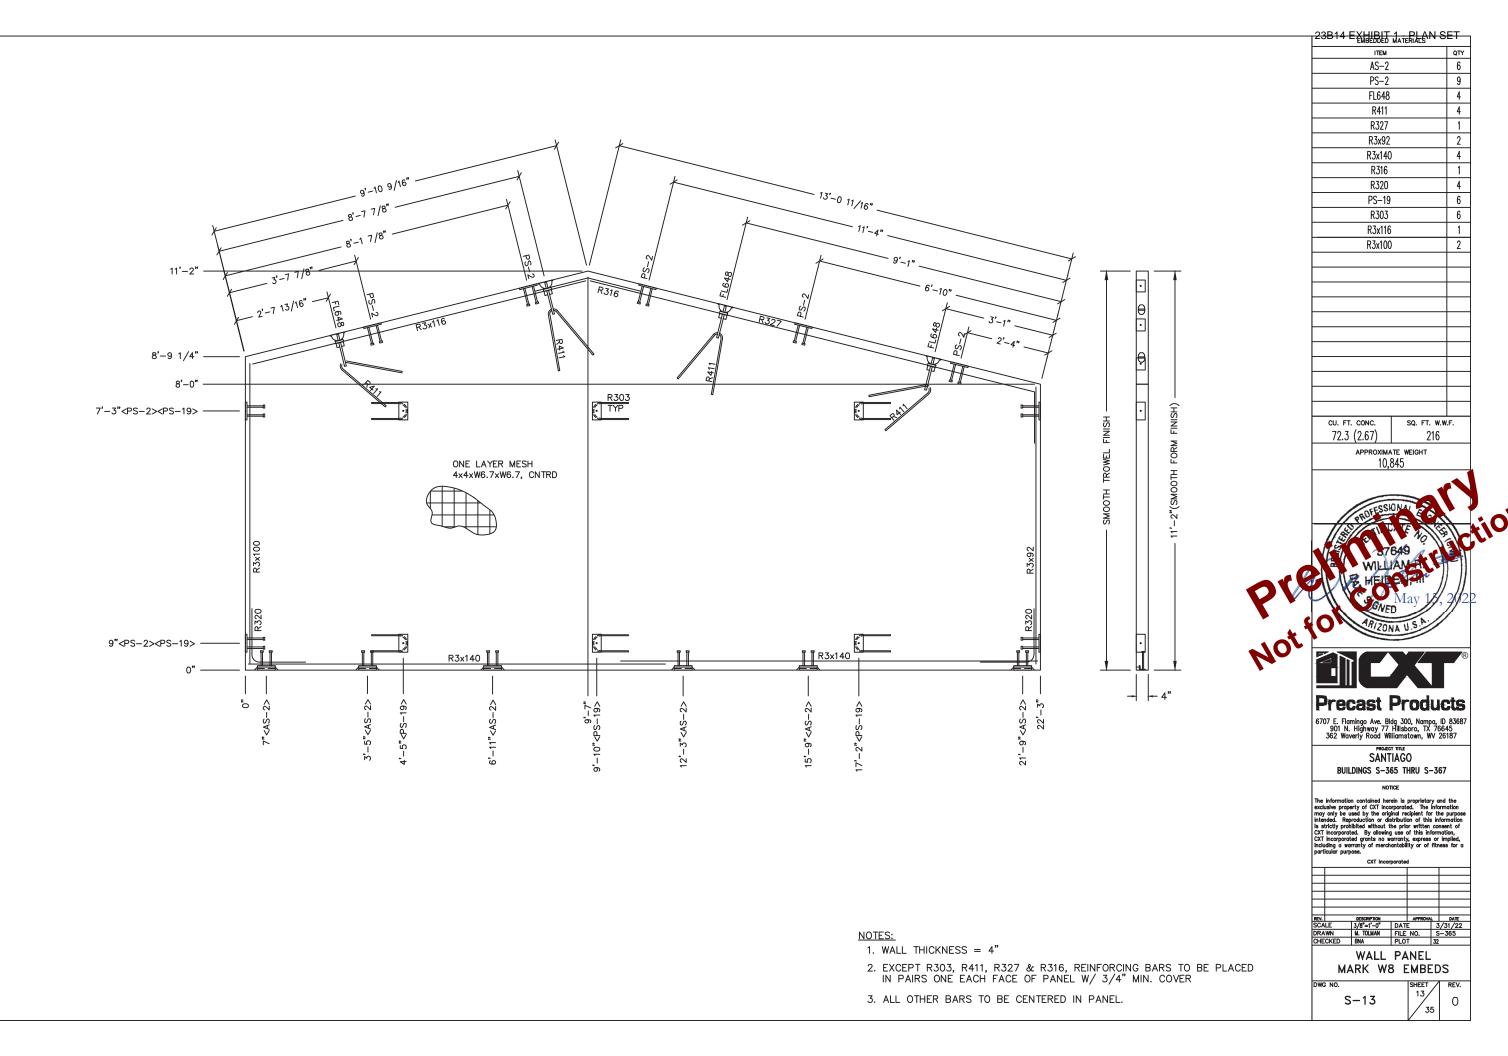
S-10


MARINE PACKAGE


2. EXCEPT R303, R322, & R3x38 REINFORCING BARS TO BE PLACED IN PAIRS ONE EACH FACE OF PANEL W/ $3/4^{\prime\prime}$ MIN. COVER




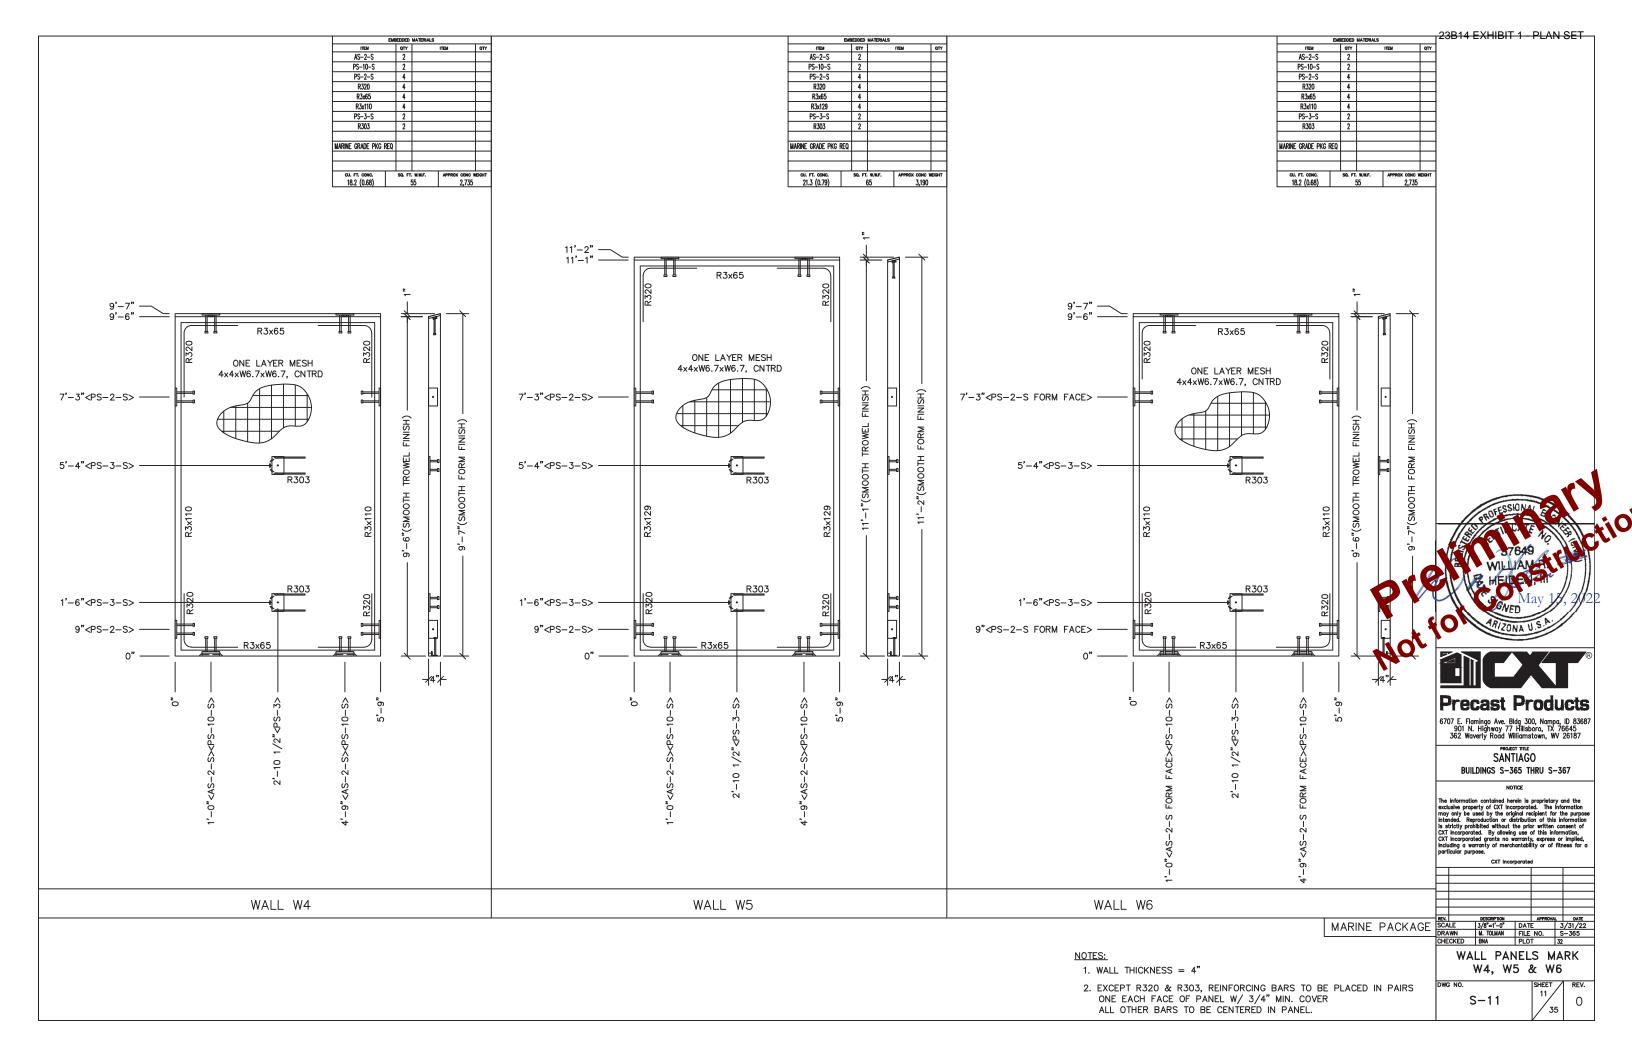

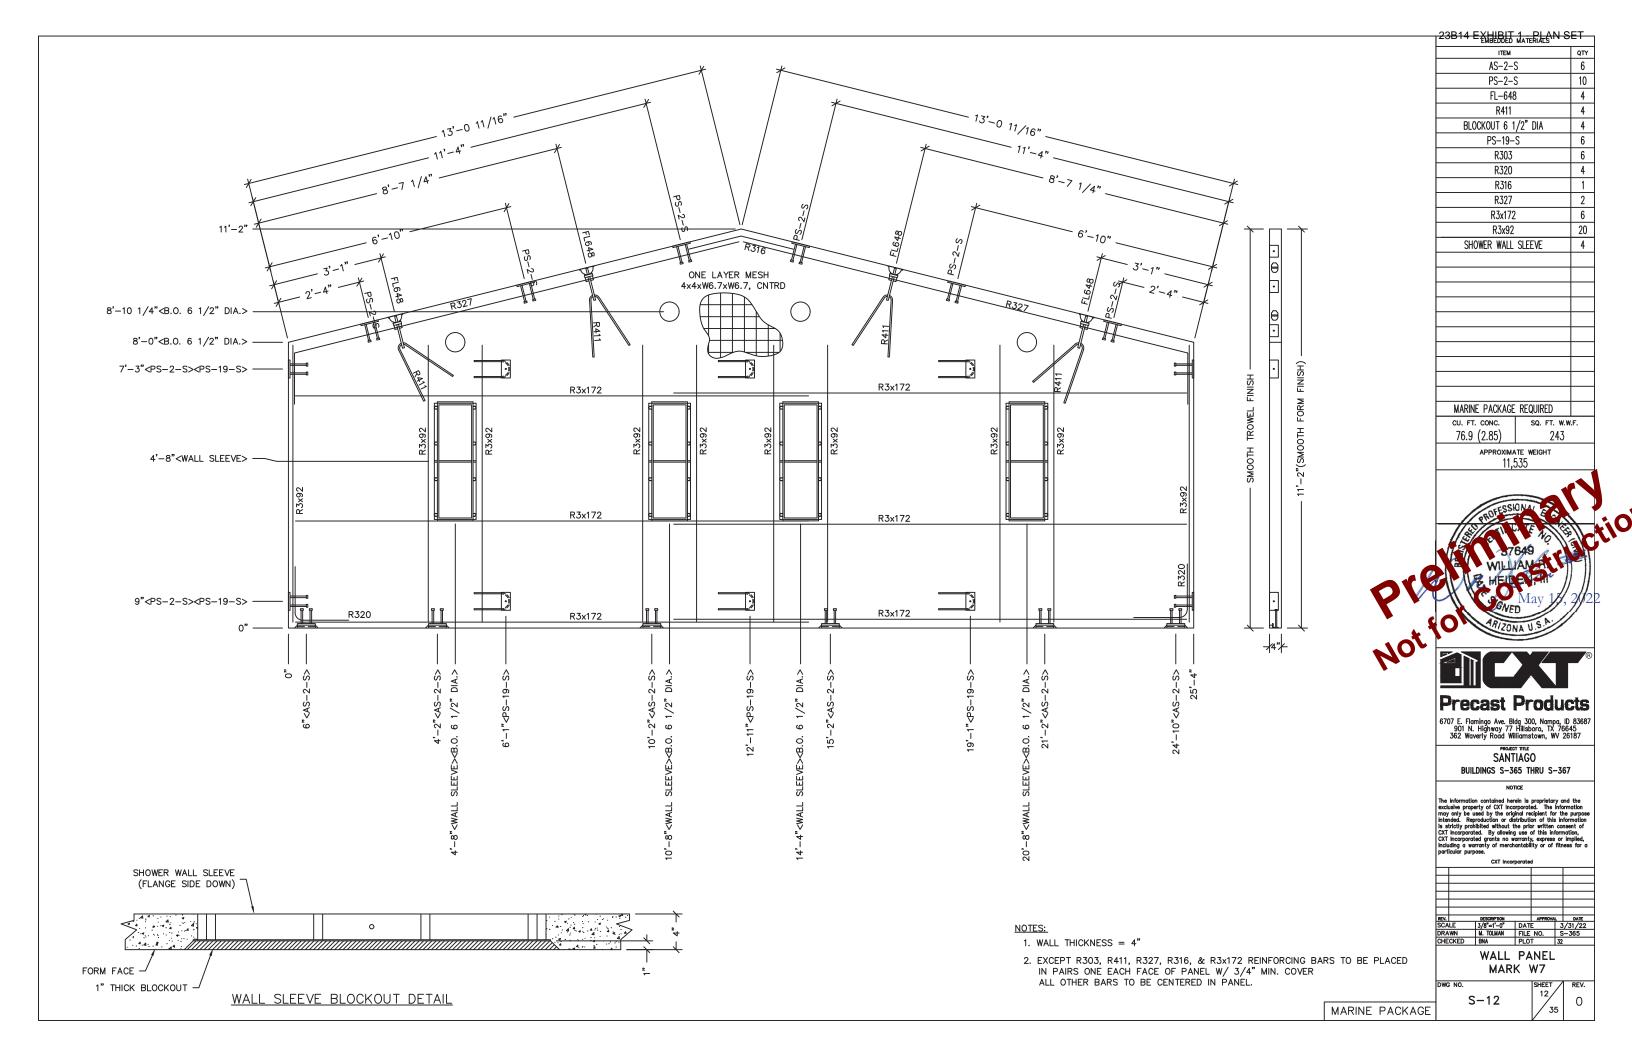

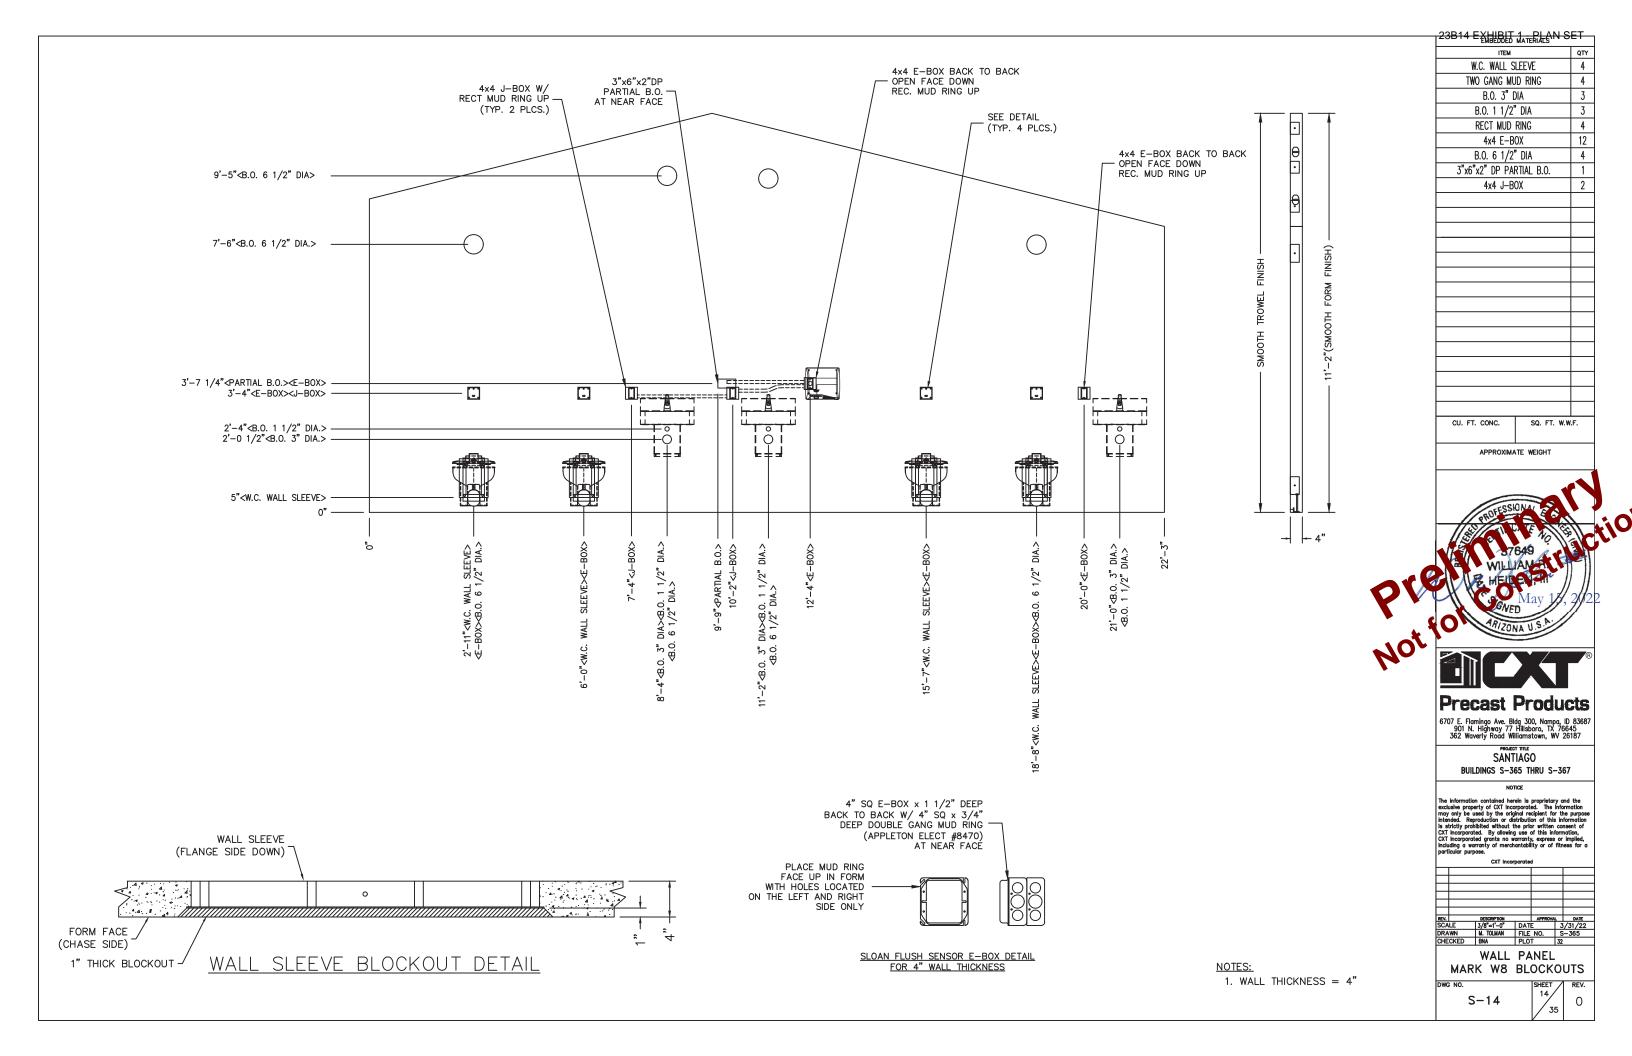

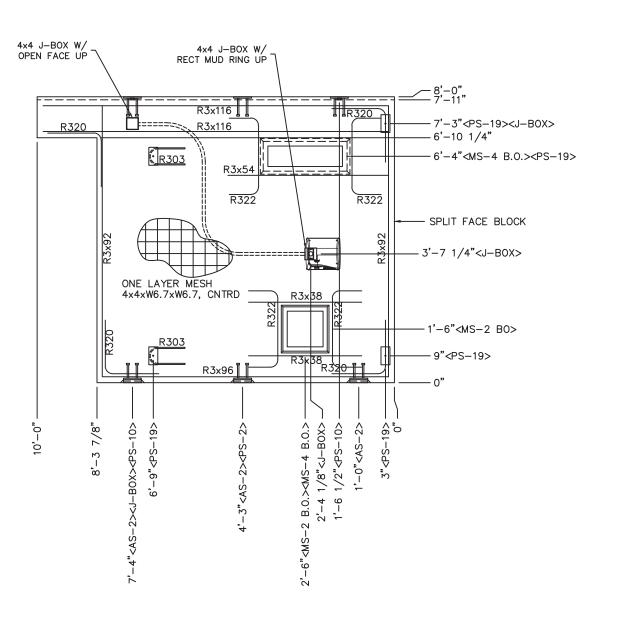

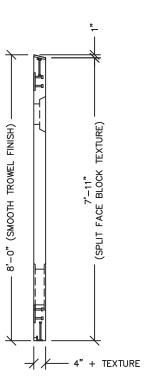

NOTES:

- 1. WALL THICKNESS = 4"+TEXTURE
- 2. EXCEPT R303, R3x38, & R322, REINFORCING BARS TO BE PLACED IN PAIRS ONE EACH FACE OF PANEL W/ 3/4" MIN. COVER
- 3. ALL OTHER REBAR TO BE CENTERED IN PANEL.

ITEM		QTY
AS-2		3
PS-10		3 2 4
PS-19		4
R303		2
PS-2		1
R3x116		4
R3x92		4
R320		8
R3x38		2
R322		4
MS-2 BLOC	KOUT	1
R3x96		2
MS-4 B.	0.	1
4x4 J-B	OX	2
RECT MUD	RING	2
R3x54		2
CU. FT. CONC.	SQ. FT. W.W	.F.
21.9 (0.81)	69	
APPROXIMA	TE WEIGHT	

23B14 EXHIBIT 1 PLAN SET

ST649
WILLIAM TO May 17, 24

ARIZONA U.S.A.



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SANTIAGO
BUILDINGS S-365 THRU S-367


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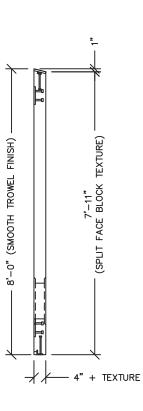
	CXT Incorporated							
REV.		DESCRIPTION		APPROVA	L	DATE		
SCA	LE	3/8"=1'-0"	DAT	E	-3	/31/22		
DRA	WN	M. TOLMAN	FILE	NO.	S	-365		
CHE	CKED	BNA	PLO	T	32			
		WALL	РΔ	NFI				

WALL PANEI MARK W9





4x4 J-BOX W/ ROUND MUD RING DOWN

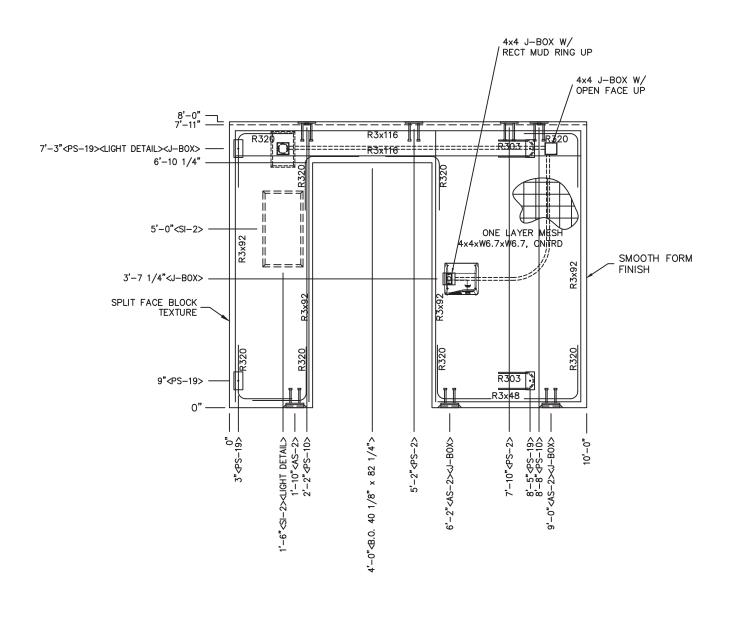

FORM FACE

LIGHT DETAIL

- 1. WALL THICKNESS = 4"+TEXTURE
- 2. EXCEPT R303, REINFORCING BARS TO BE PLACED IN PAIRS ONE EACH FACE OF PANEL W/ 3/4" MIN. COVER
- 3. ALL OTHER REBAR TO BE CENTERED IN PANEL.

LMDLDDLD	MA ILNIALS	
ITEM		QΤ
AS-2		3
PS-2		3 2 2 6
PS-10		2
PS-19		6
R3x92		8
R3x116		4
R320		16
R303		2
R3x48		2
B.O. 40 1/8" x	82 1/4"	1
SI-2		1
ROUND MUD	RING	1
4x4 J-B	OX	3
RECT MUD	RING	1
CU. FT. CONC.	SQ. FT. W.W	.F.
18.8 (0.70)	80	
-	TE WEIGHT	
2.8	320	

23B14 EXHIBIT 1 PLAN SET




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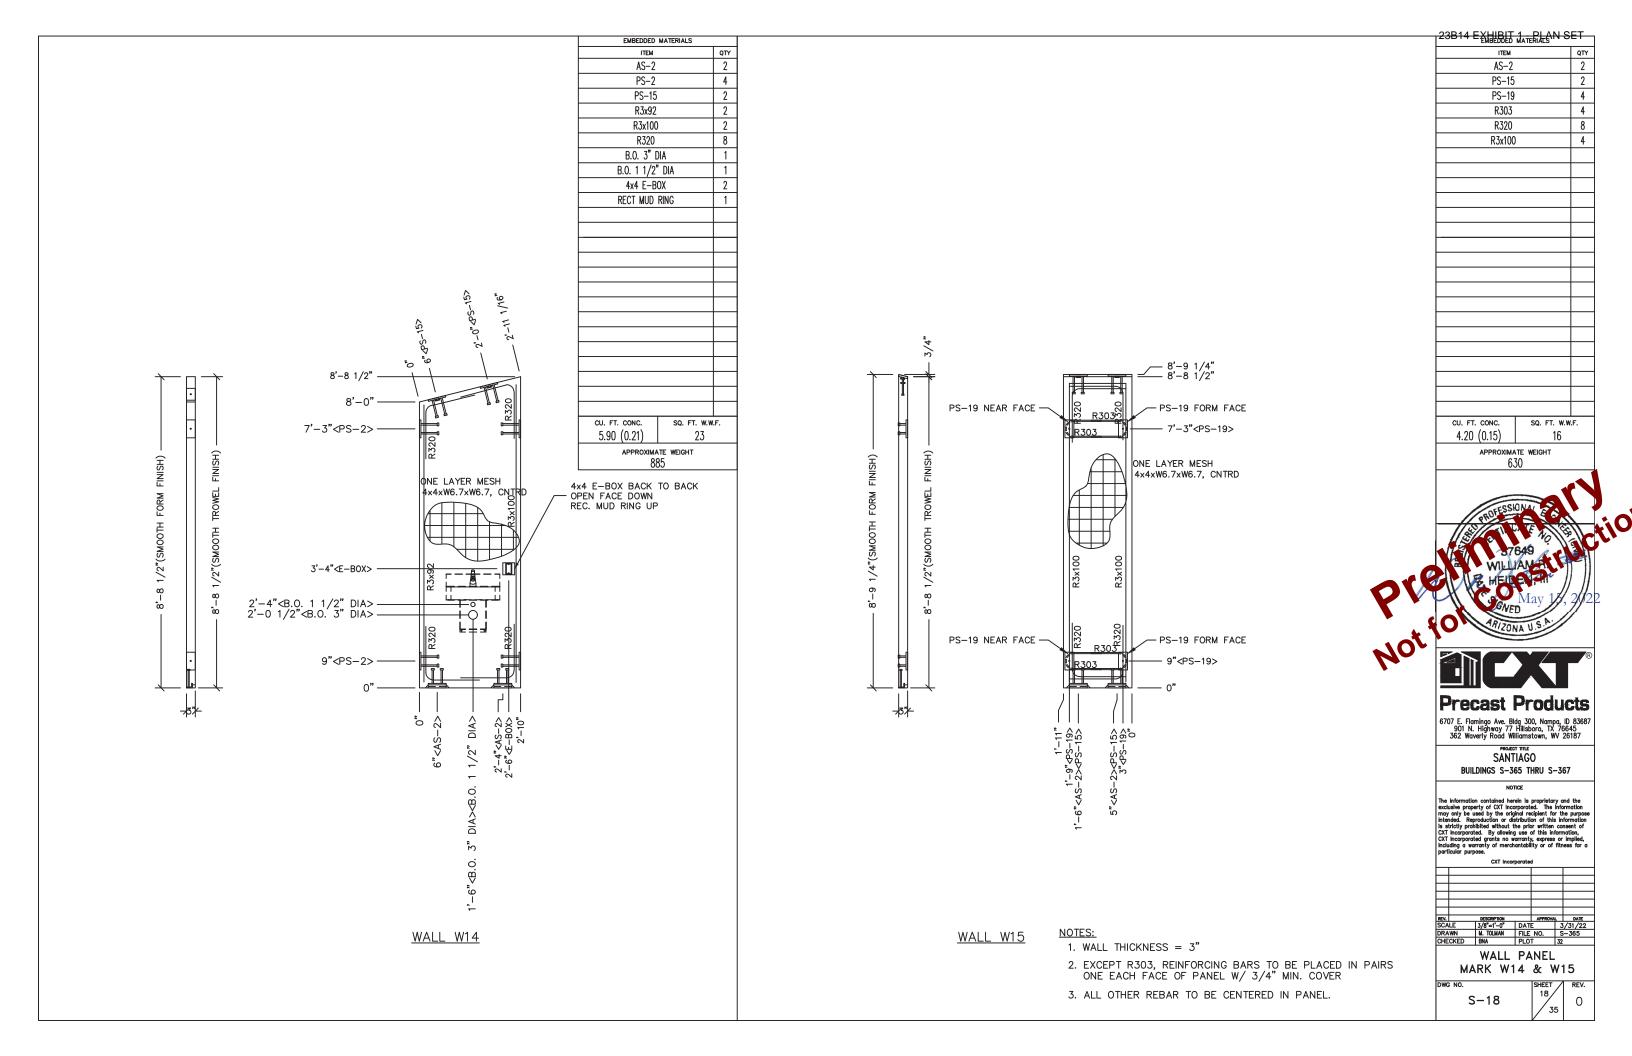
SANTIAGO BUILDINGS S-365 THRU S-367


	CXT Incorporated							
REV.		DESCRIPTION		APPROVA		DATE		
SCA		3/8"=1'-0"	DAT	E	3	/31/22		
DRA		M. TOLMAN	FILE	NO.	S	-365		
CHE	CKED	BNA	PLO	T	32			
		WALL	РΔ	NFI				


WALL PANEL MARK W10


S-16




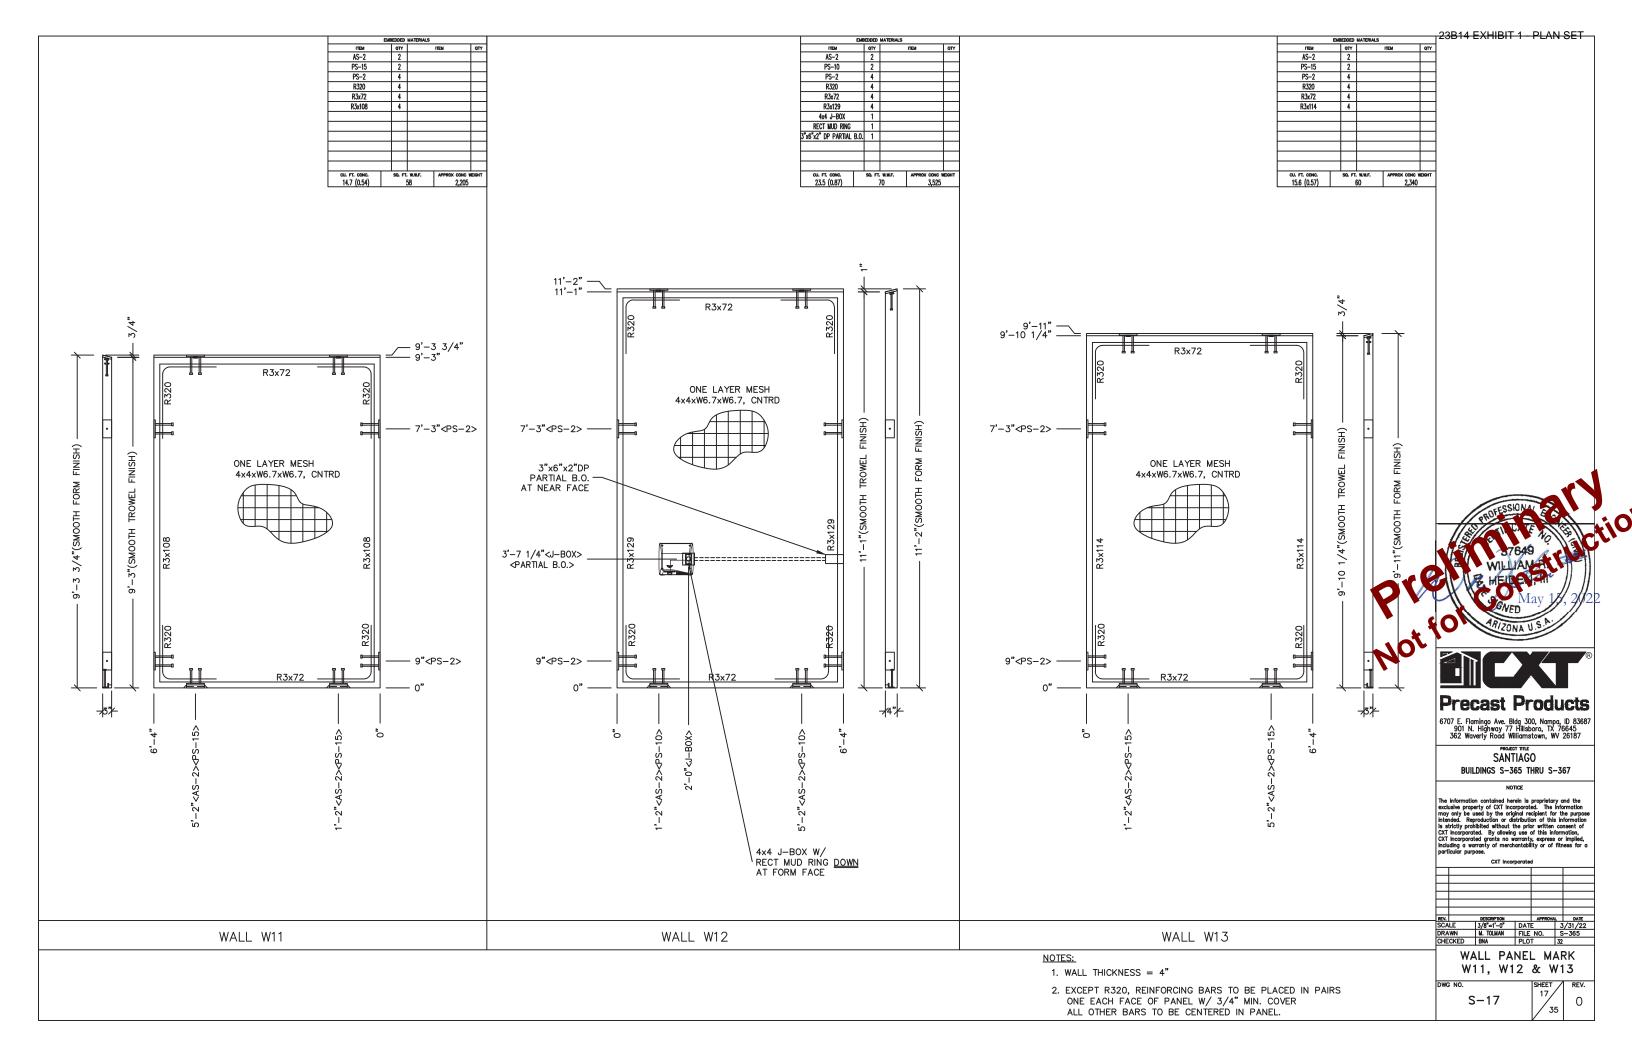

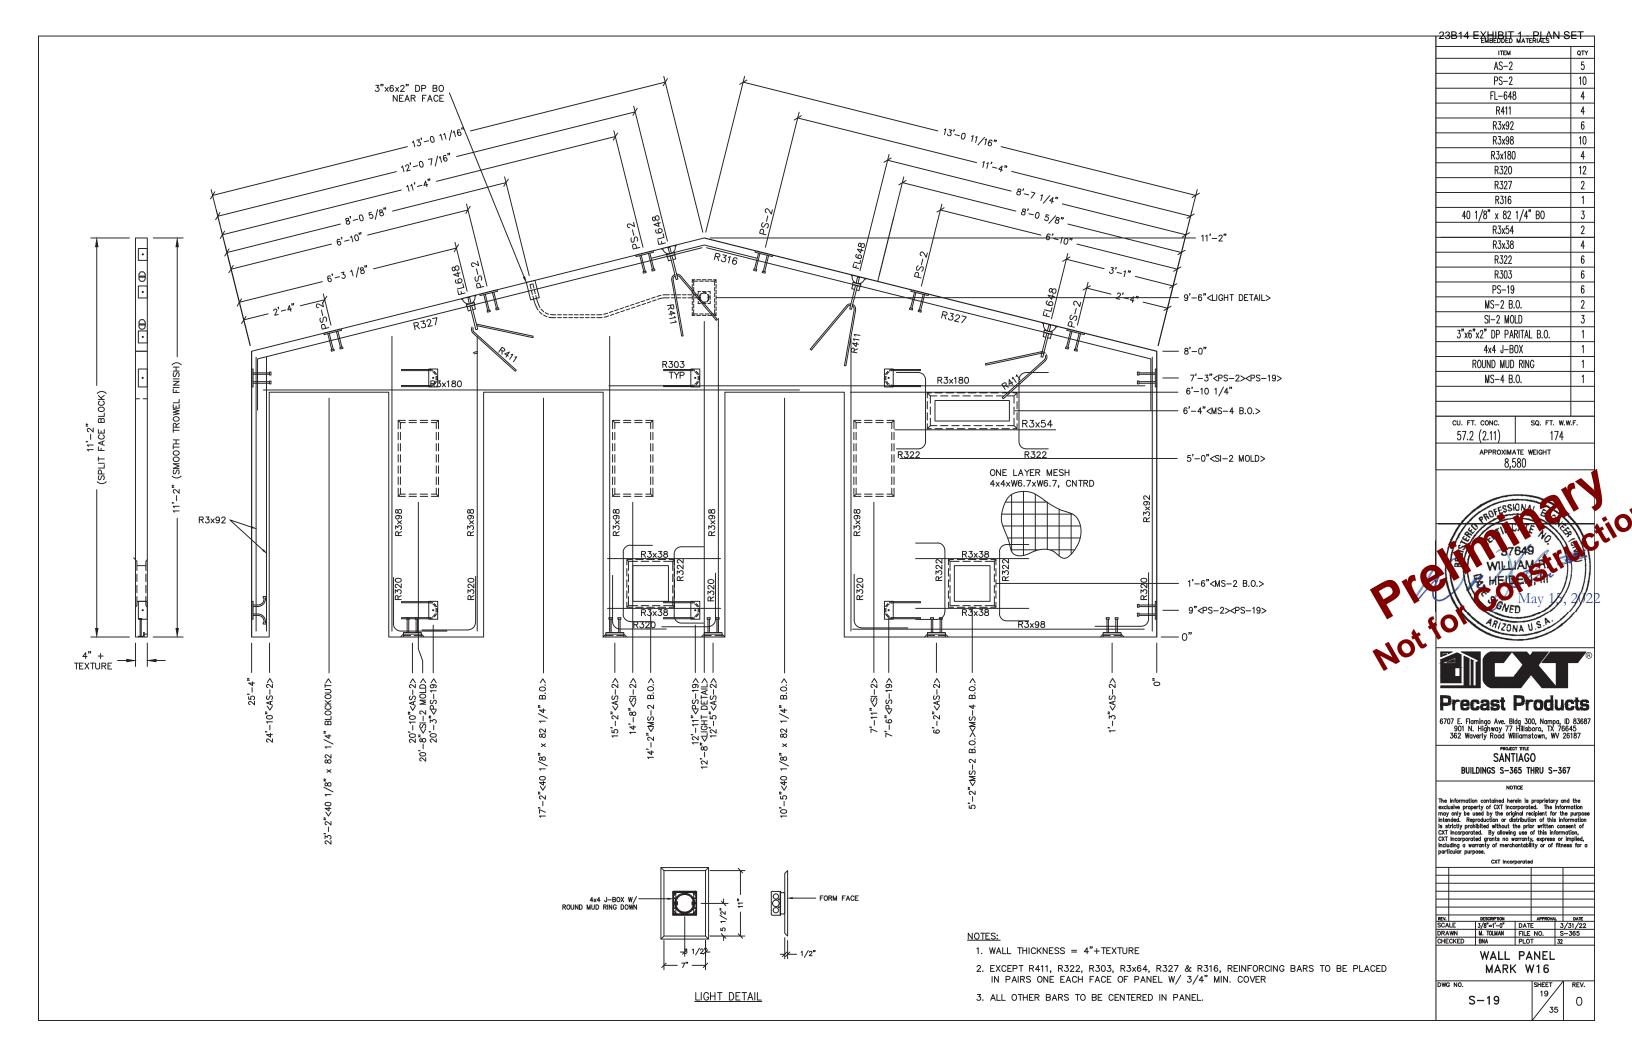

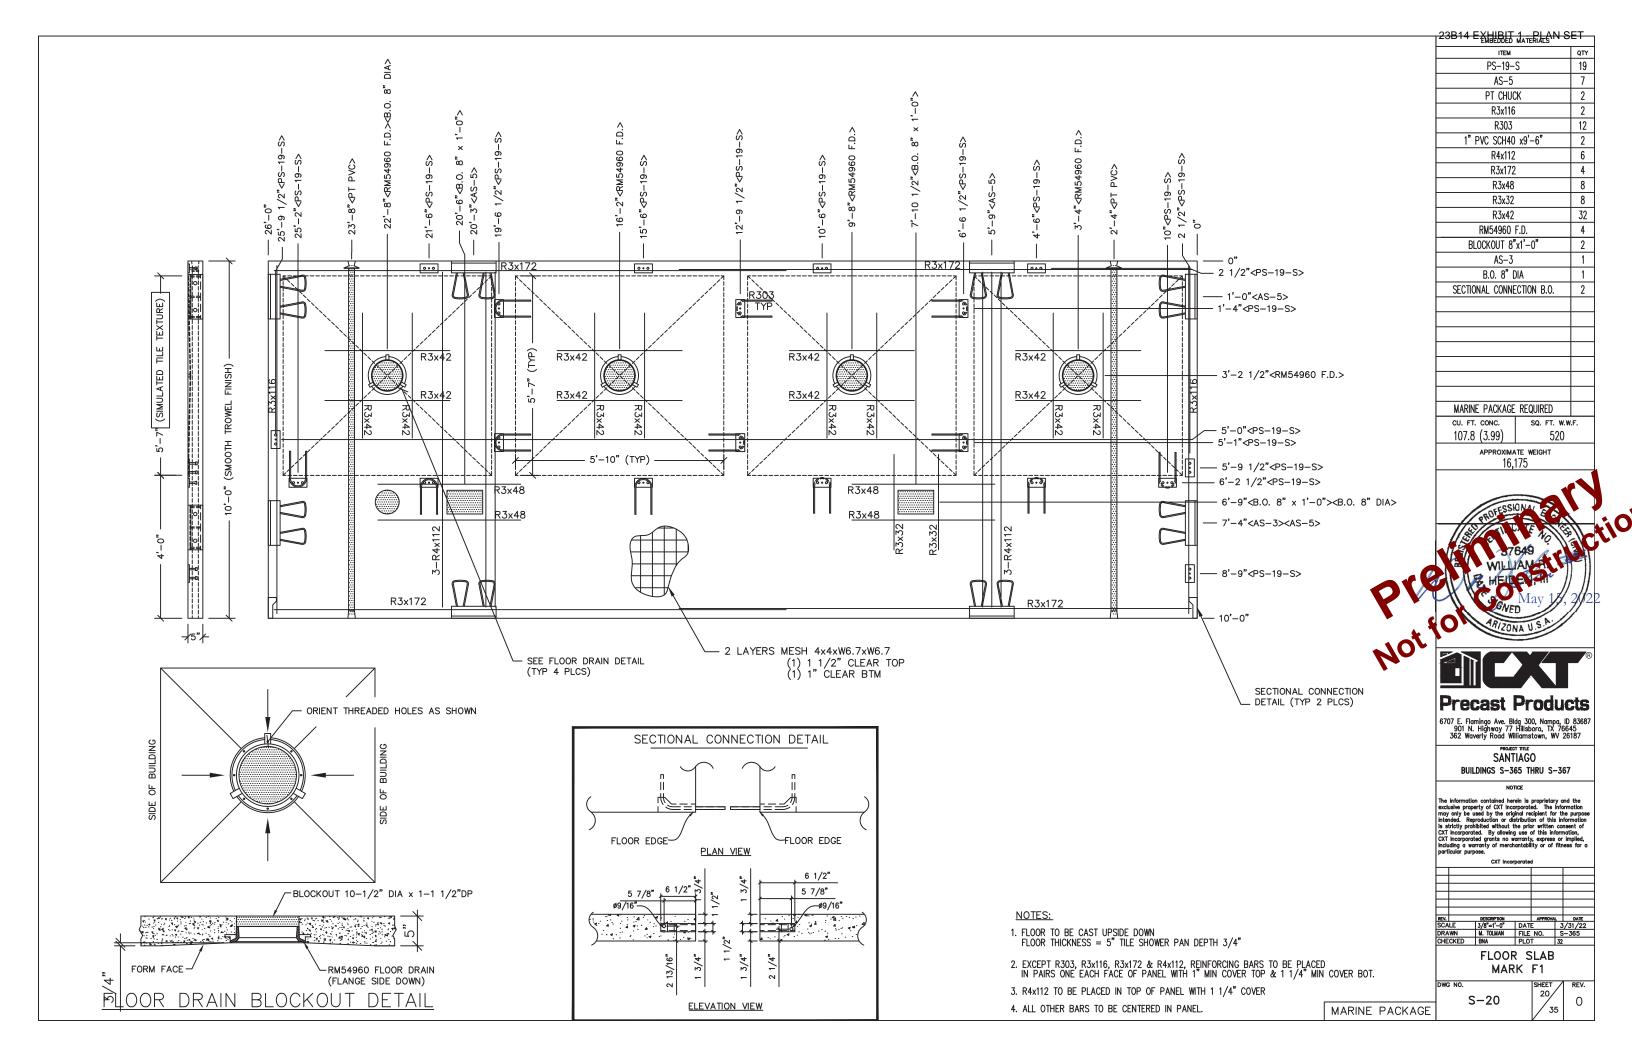

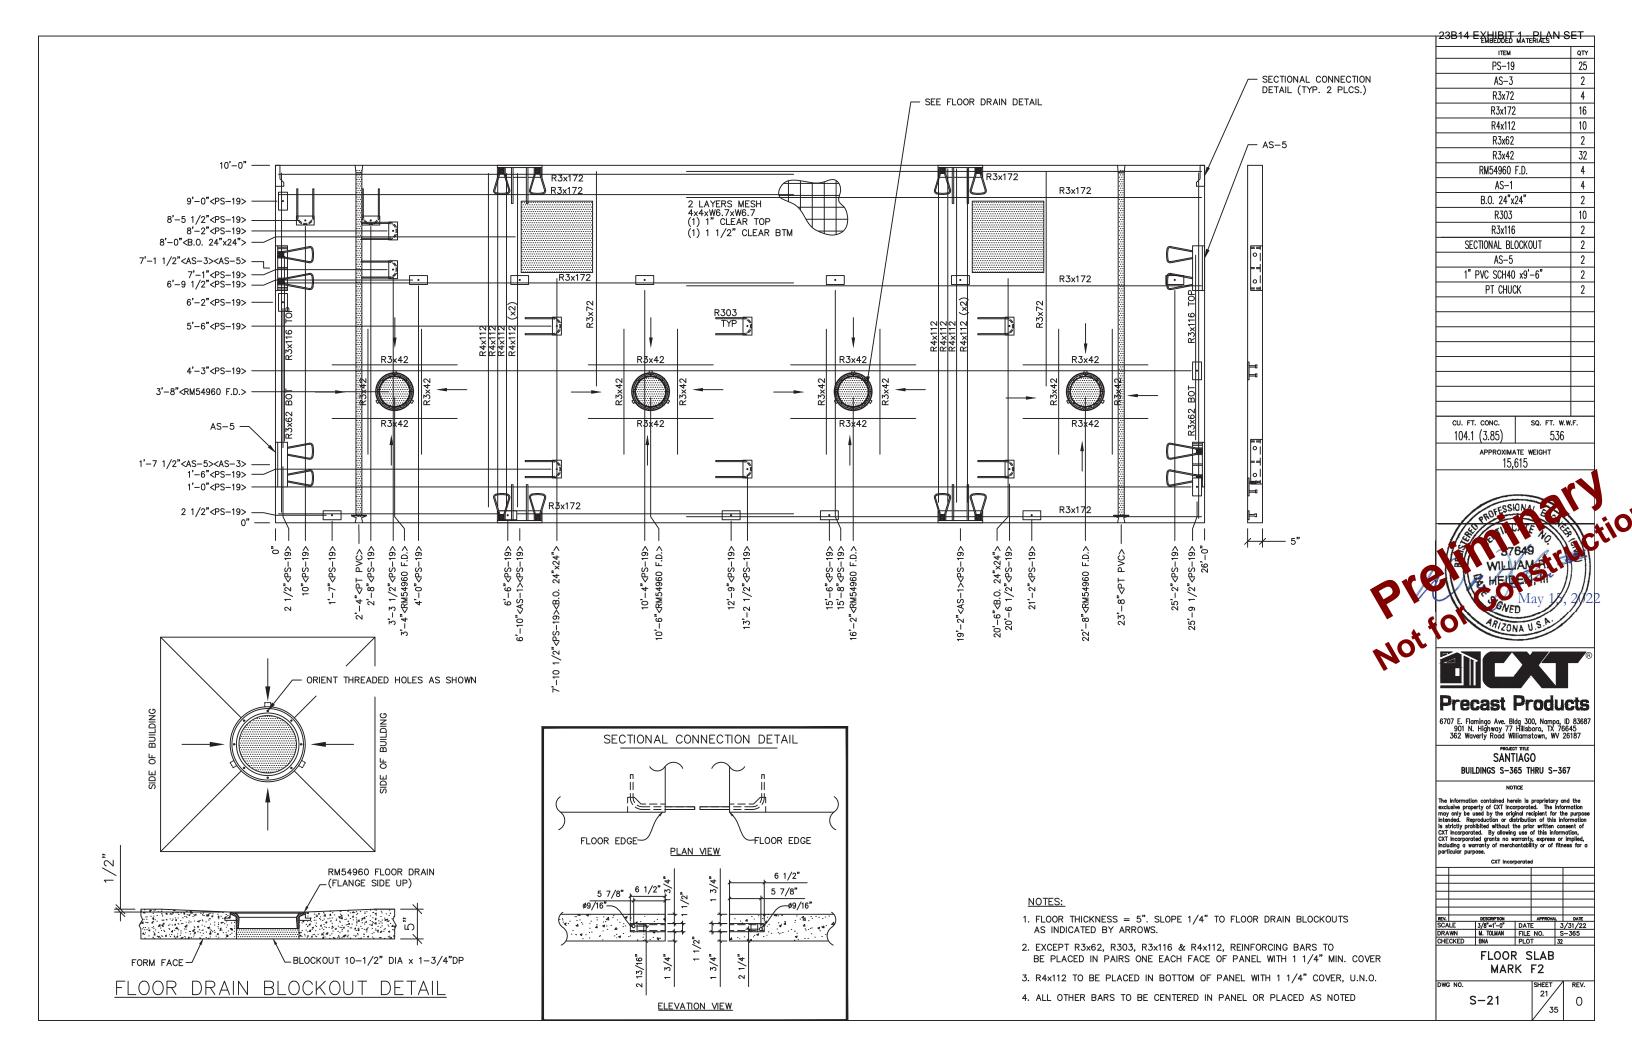


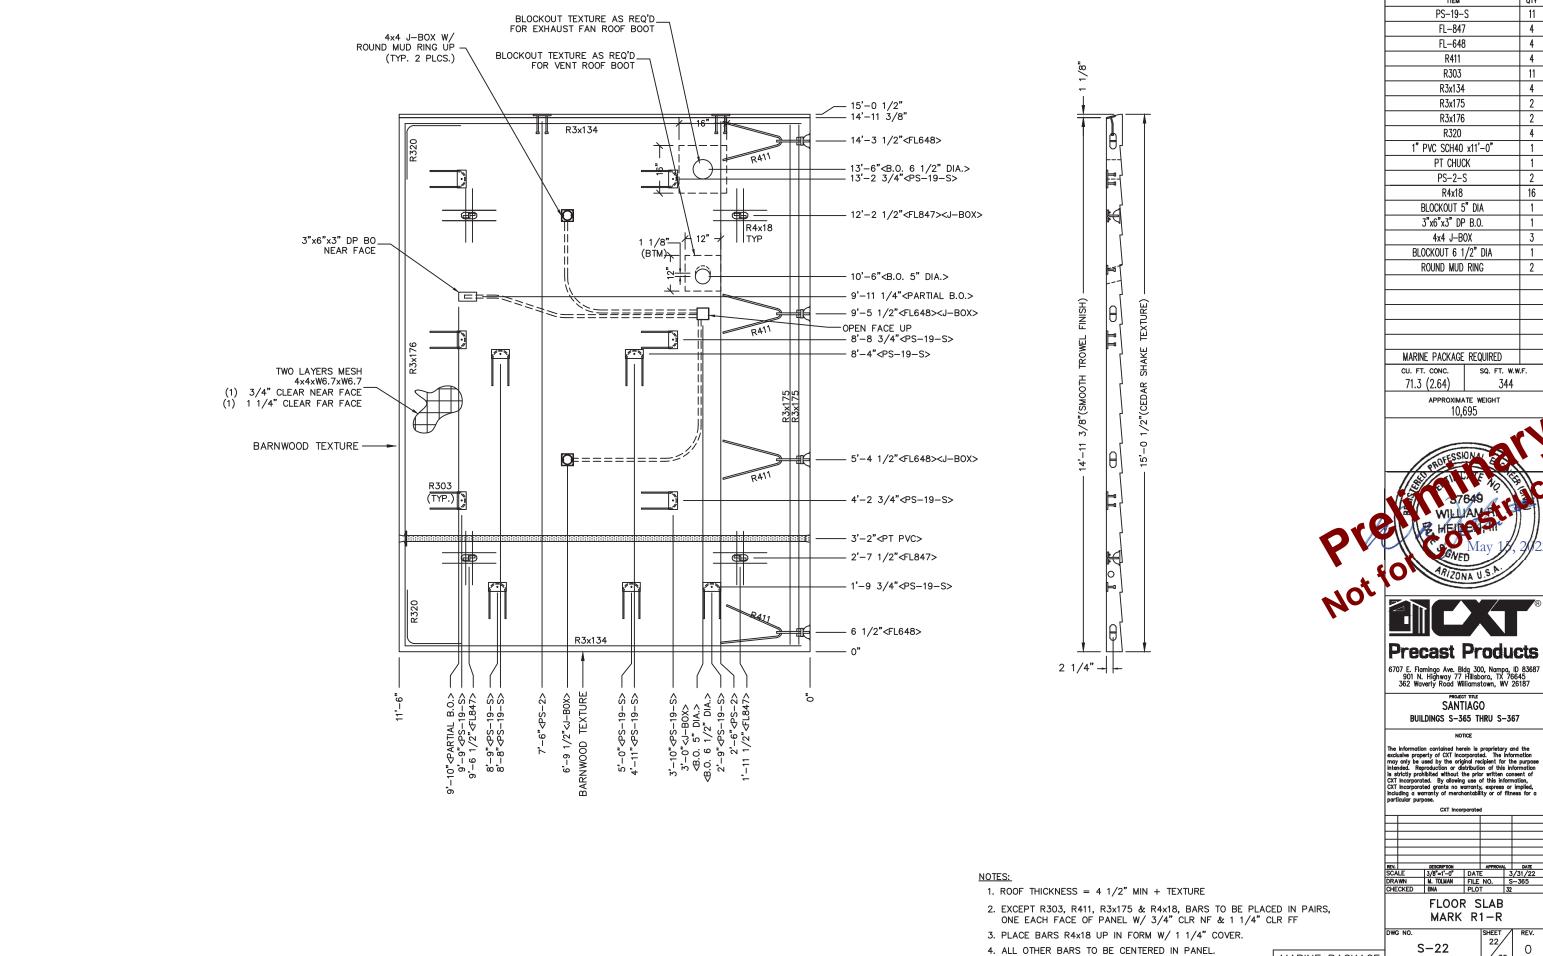

23B14 EXHIBIT 1 PLAN SET

ITEM		QT
PS-19-	S	11
FL-847	'	4
FL-648	3	4
R411		4
R303		11
R3x134		4
R3x175	;	2
R3x176		2
R320		4
1" PVC SCH40	x11'-0"	1
PT CHUC	Ж	1
PS-2-5	3	2
R4x18		16
BLOCKOUT 5	" DIA	1
3"x6"x3" DF	B.O.	1
4x4 J-B		3
BLOCKOUT 6 1	/2" DIA	1
ROUND MUD	RING	2
MARINE PACKAGE	REQUIRED	
CU. FT. CONC.	SQ. FT. W.W.	F.
71.3 (2.64)	344	
APPROXIMA		
10.0	395	

MARINE PACKAGE

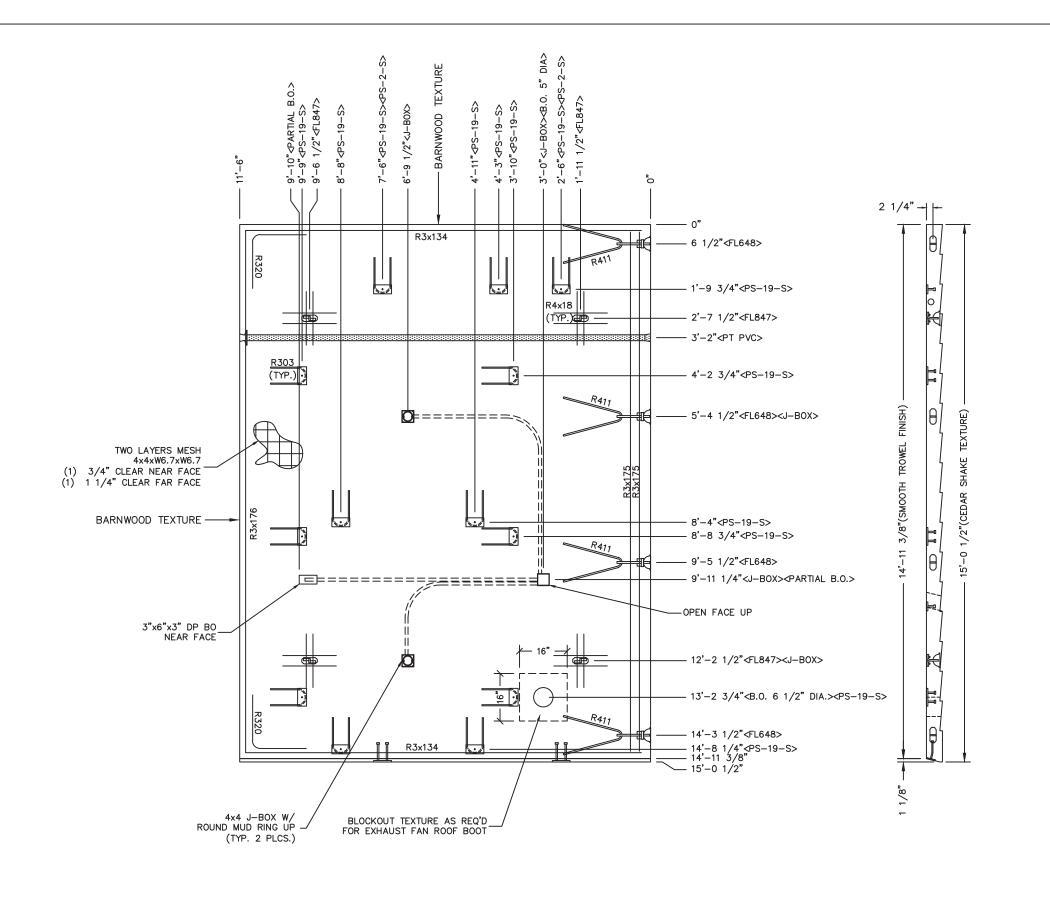

- 1. ROOF THICKNESS = $4 \frac{1}{2}$ " MIN + TEXTURE
- 2. EXCEPT R303, R411, R3x175 & R4x18, BARS TO BE PLACED IN PAIRS, ONE EACH FACE OF PANEL W/ 3/4" CLR NF & 1 1/4" CLR FF
- 3. PLACE BARS R4x18 UP IN FORM W/ 1 1/4" COVER.
- 4. ALL OTHER BARS TO BE CENTERED IN PANEL.

MARINE PACKAGE

23B14 EXHIBIT 1 PLAN SET 13 PS-19-S FL-847 4 FL-648 4 R411 4 13 R303 4 R3x134 R3x175 2 R3x176 2 R320 4 1" PVC SCH40 x11'-0" 1 PT CHUCK 1 PS-2-S 2 16 R4x18 B.O. 6 1/2" DIA 1 3"x6"x3" DP B.O. 4x4 J-B0X 3 ROUND MUD RING 2 MARINE PACKAGE REQUIRED CU. FT. CONC. 71.3 (2.64) APPROXIMATE WEIGHT 10,695



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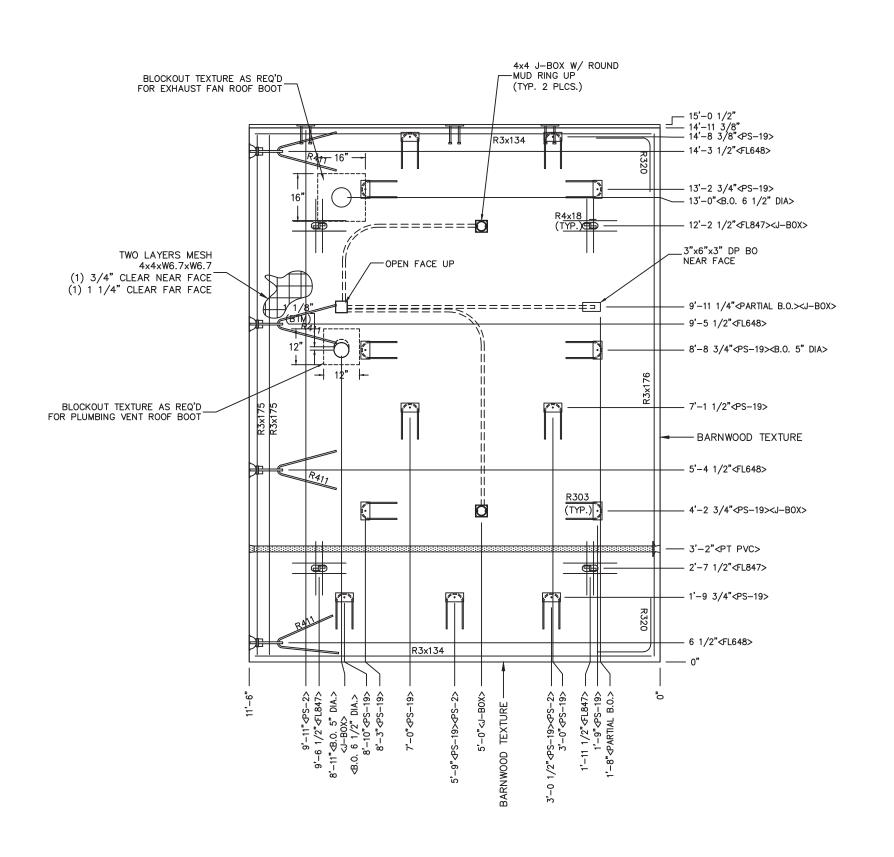
SANTIAGO BUILDINGS S-365 THRU S-367


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particular parpoon									
	CXT Incorporated								
REV.		DESCRIPTION		APPROVA	L	DATE			
SCA	LE	3/8"=1'-0"	DAT	E	3	/31/22			
DRA	WN	M. TOLMAN	FILE	NO.	S	-365			
CHE	CKED	BNA	PLO	T	32				
		FLOOF	? S	LAB					

MARK R1-L

S-23



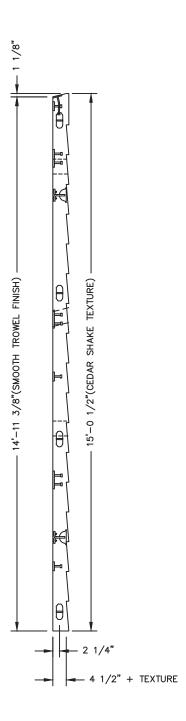

NOTES:

- 1. ROOF THICKNESS = $4 \frac{1}{2}$ MIN + TEXTURE
- 2. EXCEPT R303, R411, R3x175 & R4x18, BARS TO BE PLACED IN PAIRS, ONE EACH FACE OF PANEL W/ 3/4" CLEAR NEAR FACE & 1 1/4" CLEAR FORM FACE
- 3. PLACE BARS R4x18 UP IN FORM W/ 1 1/4" COVER
- 4. ALL OTHER BARS TO BE CENTERED IN PANEL

PS-2		3
FL648		4
FL847		4
R411		4
R303		16
R320		4
R3x176		2
R3x134		
R3x175	,	2
R4x18		16
BLOCKOUT 5	" DIA	2
4x4 J-B0	OX	3
3"x6"x3" DP	B.O.	1
ROUND MUD	RING	2
B.O. 6 1/2	' DIA	1
1" PVC SCH40	x11'-0"	1
PT CHUC		1
CU. FT. CONC.	SQ. FT. W.W	.F.
71.3 (2.64)	340	
APPROXIMA		

23B14 EXHIBIT 1 PLAN SET

PS-19

16

Precast Products

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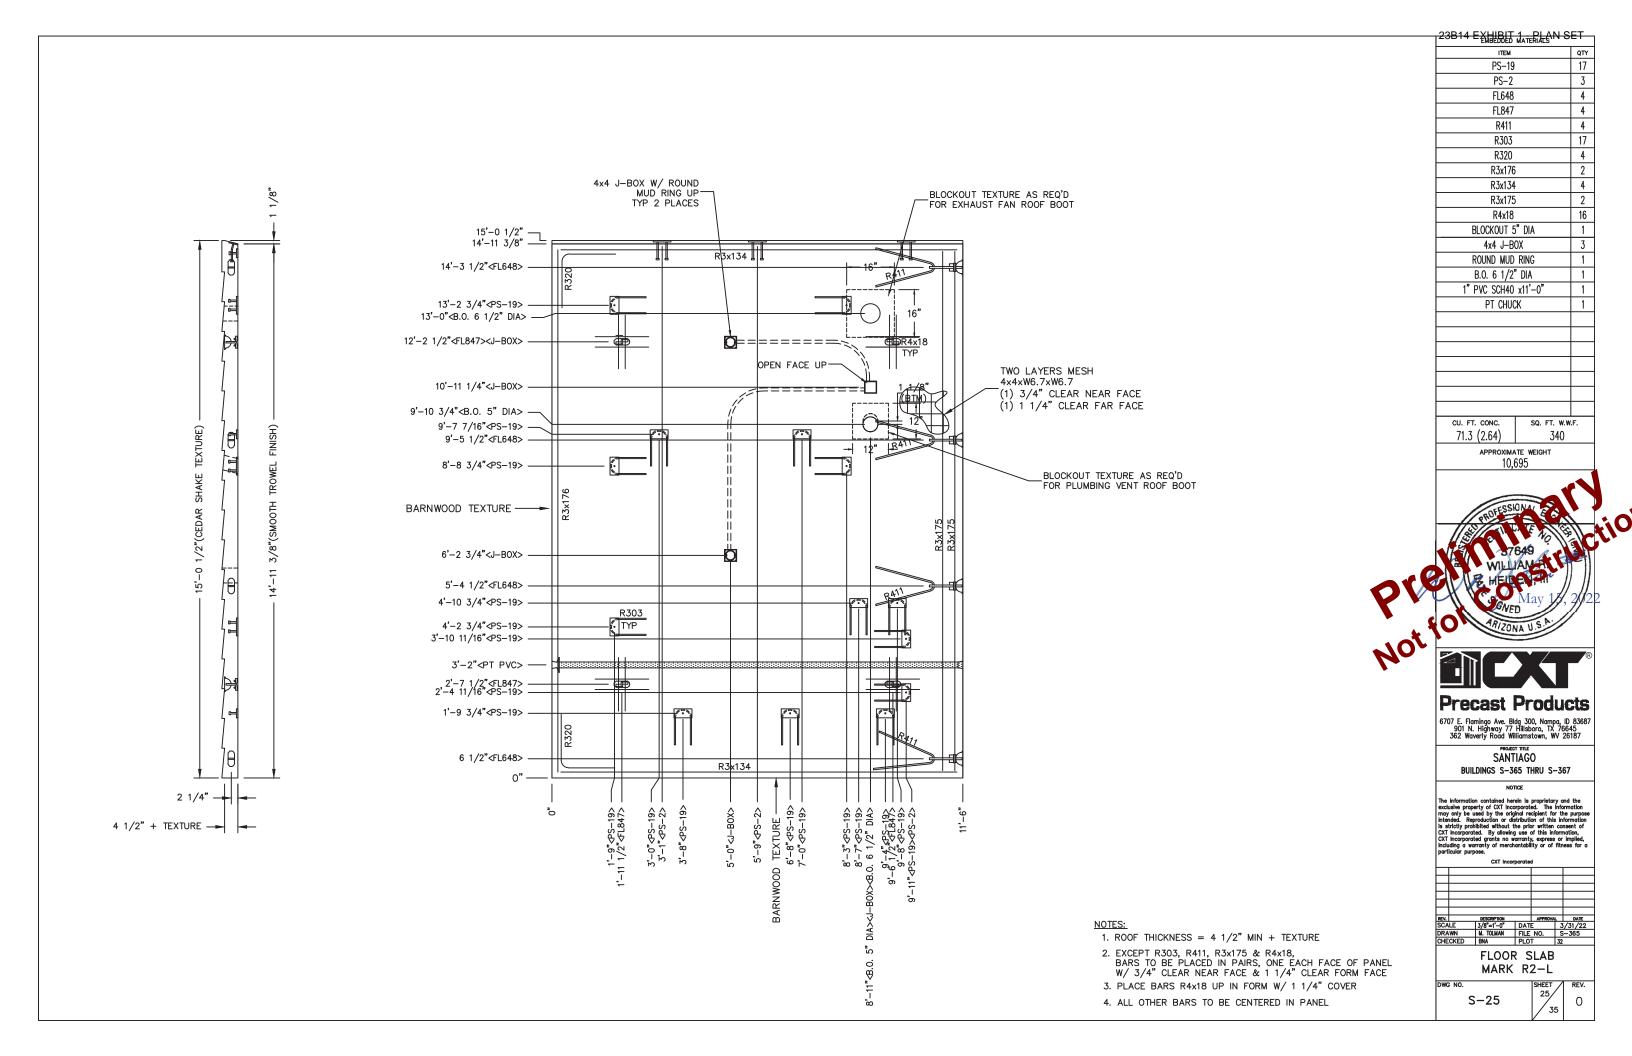
SANTIAGO BUILDINGS S-365 THRU S-367


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FLOOR SLAB

MARK R2-R

DWG NO. S-24



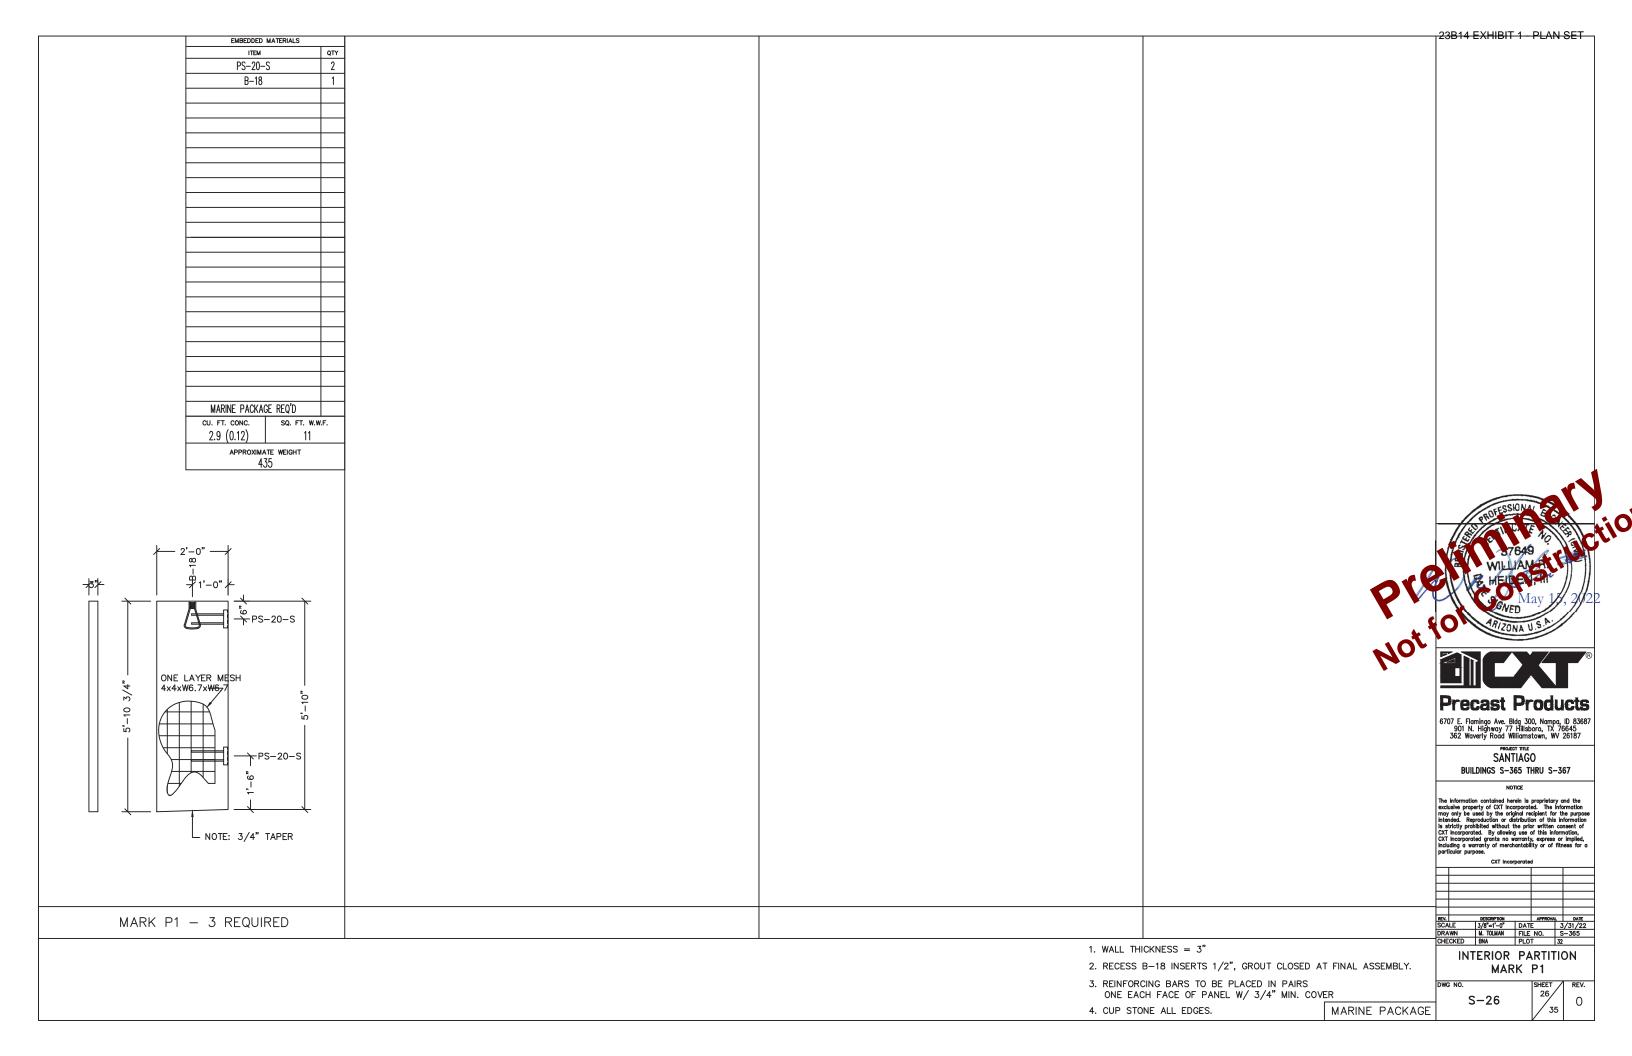


NOTE:

THIS FACTORY ASSEMBLED BUILDING, AS CONSTRUCTED, PROVIDES A RIGID BOX TYPE STRUCTURAL SYSTEM. VERTICAL LOADS ARE TRANSFERRED PRIMARILY THROUGH BEARING WALLS TO THE STRUCTURAL SLAB FLOOR OF THE BUILDING. THE VERTICAL LOADS ARE THEN DISTRIBUTED THROUGH THE REINFORCED CONCRETE FLOOR TO THE PREPARED GRANULAR, NON-FROST SUSCEPTIBLE (NFS) SUB-BASE WHICH DISTRIBUTES THE VERTICAL LOADS IN RELATIVELY UNIFORM FASHION TO THE NATIVE SUB-GRADE. AS WITH MOST CONSTRUCTION, THIS DOES REQUIRE THE NATIVE SUB-GRADE TO BE STRIPPED OF VEGETATION AND TOP SOIL PRIOR TO PLACEMENT OF THE PREPARED GRANULAR SUB-BASE. DUE TO THE INHERENT STIFFNESS OF THE BUILDING, IT WILL REMAIN SAFE AND STRUCTURALLY SOUND IN THE UNLIKELY EVENT OF FREEZING ACTION BELOW THE BUILDING REGARDLESS OF NATURAL FREEZE/ THAW CYCLES ANTICIPATED TO BE ENCOUNTERED IN THE STATE OF ARIZONA.

LATERAL LOADS ARE TRANSFERRED TO THE GROUND THROUGH FRICTIONAL RESISTANCE WITHOUT SLIDING OR SHIFTING BETWEEN THE BUILDING FLOOR SLAB AND THE PREPARED SOIL AND GRAVEL SUB-BASE ON WHICH THE BUILDING RESTS. SEISMIC ANALYSES ARE BASED ON LOADS DETERMINED IN ACCORDANCE WITH THE INTERNATIONAL BUILDING CODE USING PARAMETERS, WHICH MEET OR EXCEED THE CODE PRESCRIBED REQUIREMENTS FOR THIS INSTALLATION.

THIS BUILDING AS DESIGNED, RESTING ON A PROPERLY PREPARED GRANULAR SUB-BASE WILL BE SAFE AND STRUCTURALLY SOUND FOR VERTICAL AND LATERAL LOADS AS DISCUSSED ABOVE. A FULL DEPTH FOUNDATION WALL AT THE BUILDING PERIMETER AND AN ANCHORAGE SYSTEM, TYPICAL FOR OTHER TYPES OF BUILDING CONSTRUCTION, ARE NOT REQUIRED FOR THIS BUILDING.

THE "FOUNDATION" FOR THIS STRUCTURE IS ESSENTIALLY THE COMBINATION OF THE COMPACTED SUB—BASE MATERIAL AND THE BUILDING'S REINFORCED SLAB. THE COMBINATION OF THE COMPACTED SUB—BASE MATERIAL AND THE BUILDING'S REINFORCED SLAB NEED TO BE AT LEAST 12" THICK AND THE COMPACTED SUB—BASE MATERIAL SHALL EXTEND BELOW THE LOCAL FROST DEPTH

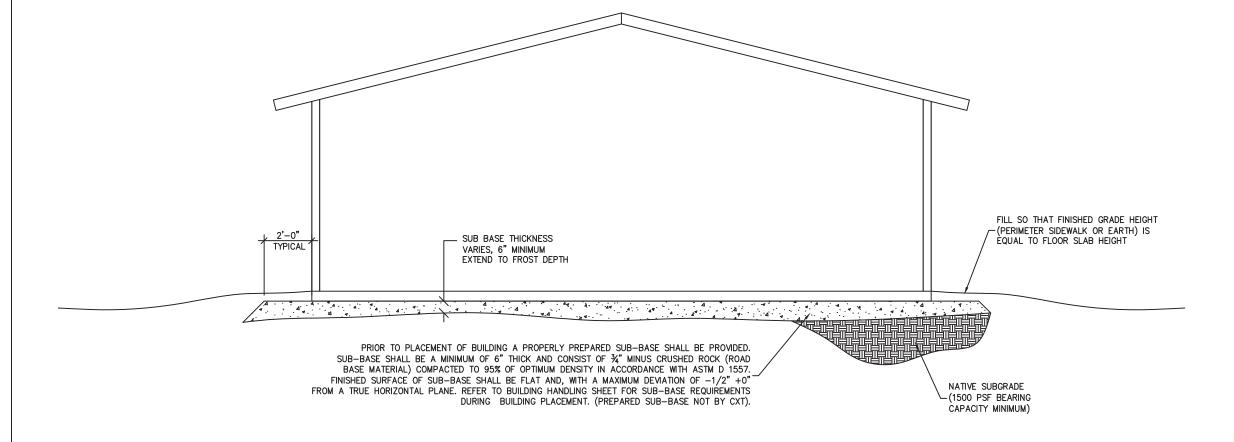

STESSIONAL CONTROL OF THE STEEL STATE OF THE STATE OF THE



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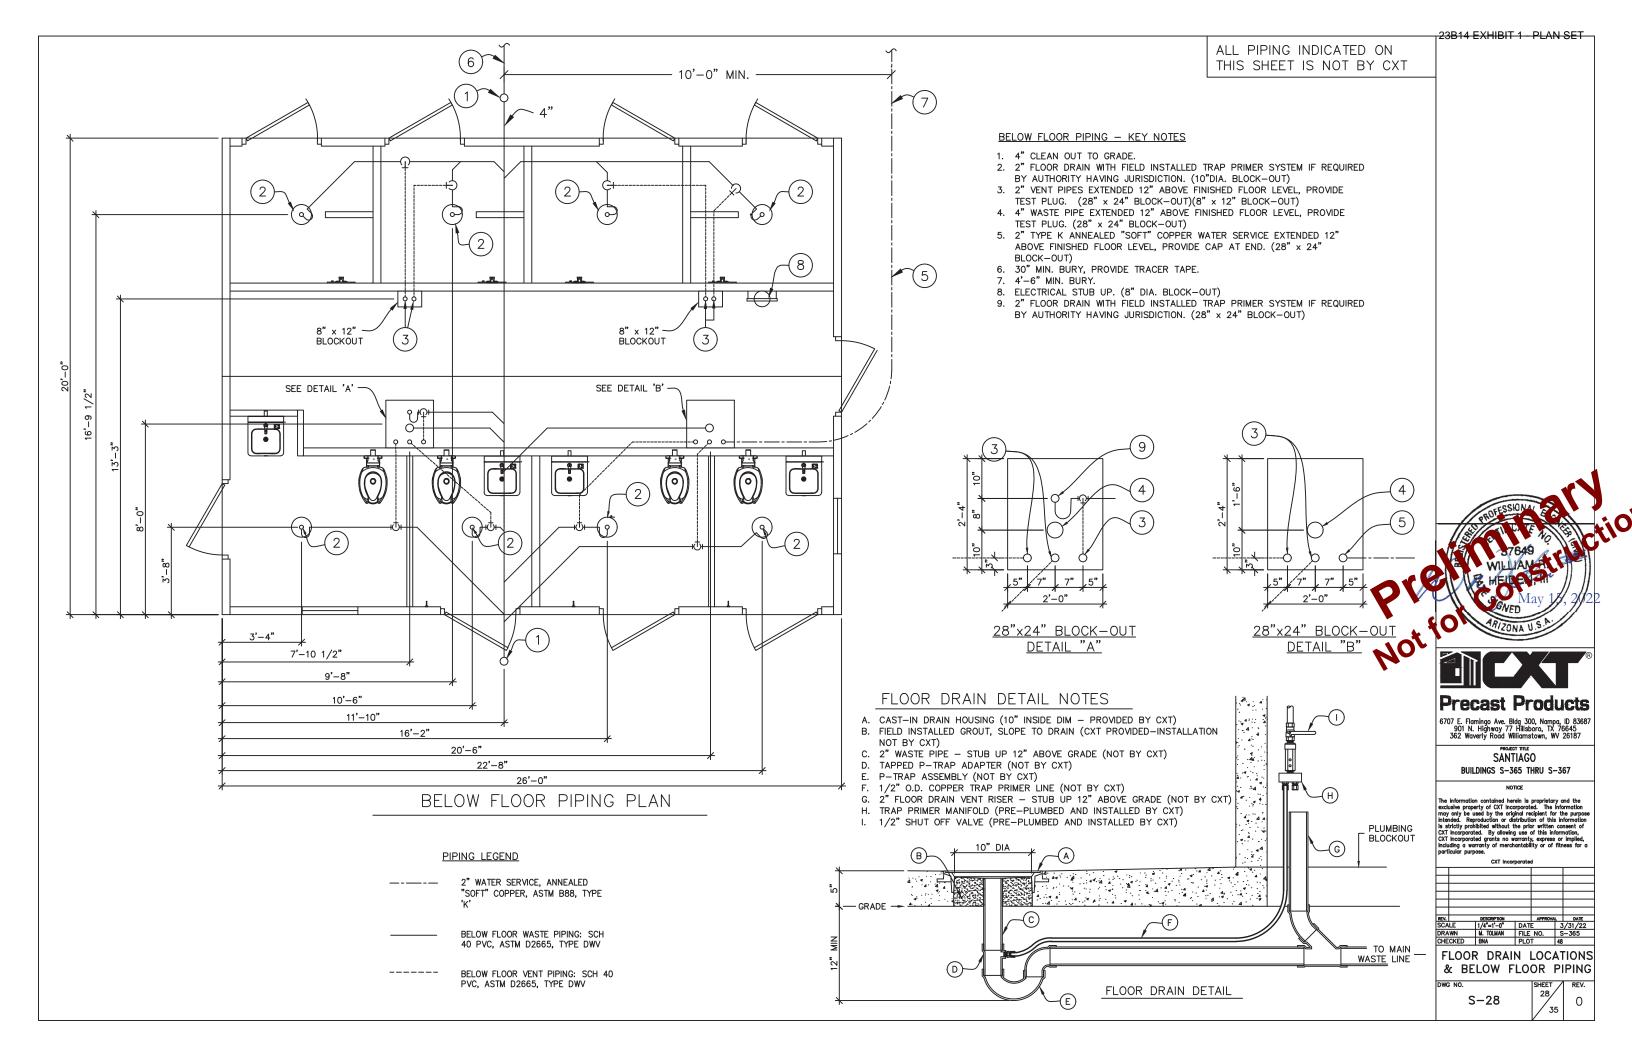
SANTIAGO
BUILDINGS S-365 THRU S-367


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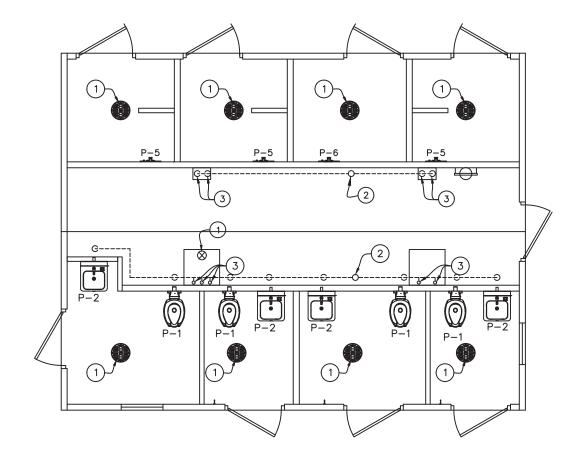
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DETAIL

S-27





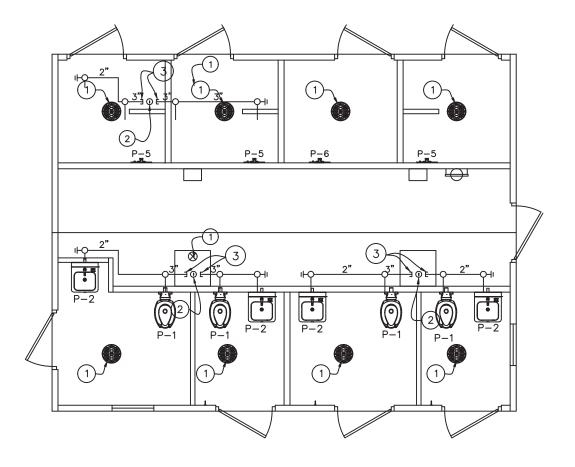

WASTE PIPING - KEY NOTES

- 1. 2" FLOOR DRAIN, FIELD INSTALLED (NOT BY CXT)
- 2. 4" WASTE THROUGH FLOOR, FIELD INSTALLED (NOT BY CXT)
- 3. PROVIDE TEST PLUGS IN END OF WASTE PIPES. CONTINUATION OF PIPING IS FIELD INSTALLED & NOT BY CXT.

PIPING LEGEND

COLD WATER; COPPER.
ASTM B88, TYPE "K"

HOT WATER; COPPER,
ASTM B88, TYPE "K"

VENT PIPING; SCH 40 PVC,
ASTM D2665, TYPE DWV

WASTE PIPE; SCH 40 PVC,
ASTM D2665, TYPE DWV

FIELD PIPING; (NOT BY CXT)

VENT PIPING - KEY NOTES

- 1. 2" FLOOR DRAIN, FIELD INSTALLED (NOT BY CXT)
- 2. VENT THROUGH ROOF.
- 3. 2" VENT WITH TEST PLUG.
- 4. FIELD INSTALLED 2" VENT PIPING FROM FLOOR DRAINS. (NOT BY CXT)

STESSOM STEAD STE




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SANTIAGO
BUILDINGS S-365 THRU S-367

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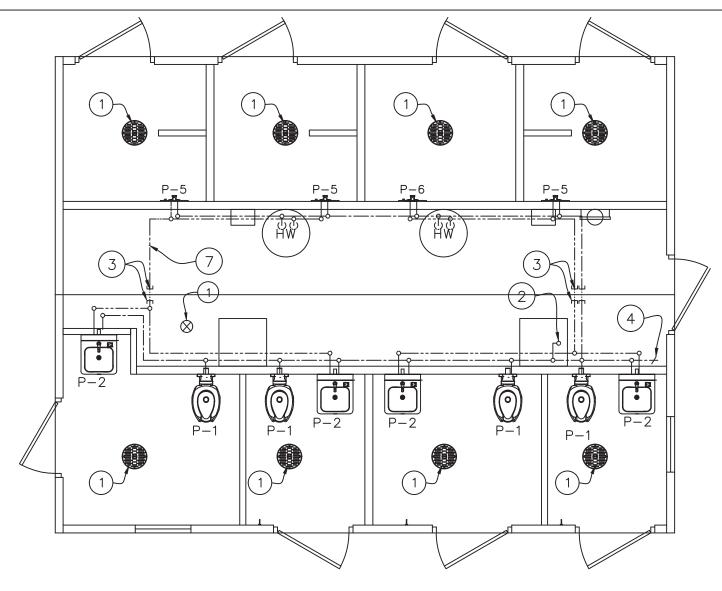
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CXT Incorporated



PLUMBING WASTE & VENT PIPING PLANS

S-29

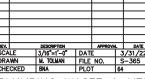

WATER PIPING PLAN

WATER PIPING - KEY NOTES

- 1. 2" FLOOR DRAIN, FIELD INSTALLED (NOT BY CXT) (10"ø AND 24" x 24" BO)
- 2. FIELD INSTALLED 2" WATER SUPPLY WITH SHUT-OFF VALVE NEAR FLOOR. (NOT BY CXT)
- 3. CAPPED WATER LINES. CONNECTION BETWEEN SIDES IS TO BE FIELD INSTALLED. (NOT BY CXT)
- 4. 3/4" HOSE BIBB WITH VACUUM BREAKER AND WHEEL HANDLE
- 5. WATER PIPING ALONG WALL, SEE DIAGRAM
- 6. WATER HEATER SECURED TO WALL
- 7. HOT WATER PIPING AT CEILING, INSTALL TO MISS LIGHT FIXTURE. INSULATE WITH 1" PRE MOLDED PIPE INSULATION.


PIPING LEGEND

COLD WATER; COPPER. ASTM B88, TYPE "K" HOT WATER; COPPER, ASTM B88, TYPE "K"

VENT PIPING; SCH 40 PVC, ASTM D2665, TYPE DWV

WASTE PIPE; SCH 40 PVC, ASTM D2665, TYPE DWV


FIELD PIPING; (NOT BY CXT)

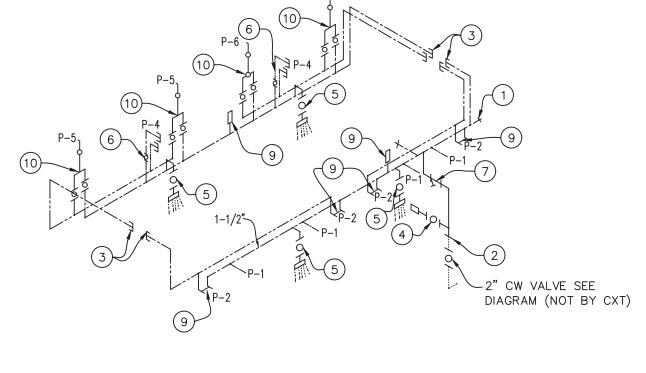

WATER PIPING RISER DIAGRAM

WATER PIPING RISER - KEY NOTES

- 1. 3/4" HOSE BIBB WITH VACUUM BREAKER. & WHEEL HANDEL
- 2. TO THIS POINT BY CXT.
- 3. PLUGGED WATER LINES TO THIS POINT, BY CXT. PIPING BETWEEN THESE POINTS, NOT BY CXT.
- 4. 1/2" AIR QUICK CONNECTION W/ BALL VALVE FOR BLOWING OUT WATER PIPING.
- 5. 1/2" BALL VALVE & CAPPED CW LINE FOR FIELD INSTALLED TRAP PRIMER VALVE IF REQUIRED BY JURISDICTION HAVING AUTHORITY
- 6. 3/4" CW TO WATER HEATER, SEE HOT WATER PIPING RISER DIAGRAM.
- 7. WYE STRAINER
- 8. ASSE 1070 WATER TEMPERATURE LIMITING DEVICE
- 9. ASSE 1010 WATER HAMMER ARRESTOR SIOUX CHIEF HYDRA-RESTOR #654-C OR EQUAL.
- 10. PROVIDE SHUT-OFF VALVES ON COLD AND HOT WATER SUPPLY FOR EACH FIXTURE
- 11. ASSE 1016 AUTOMATIC COMPENSATING VALVE

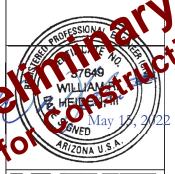





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SANTIAGO BUILDINGS S-365 THRU S-367

PLUMBING WATER PIPING PLAN & DIAGRAMS

S - 30



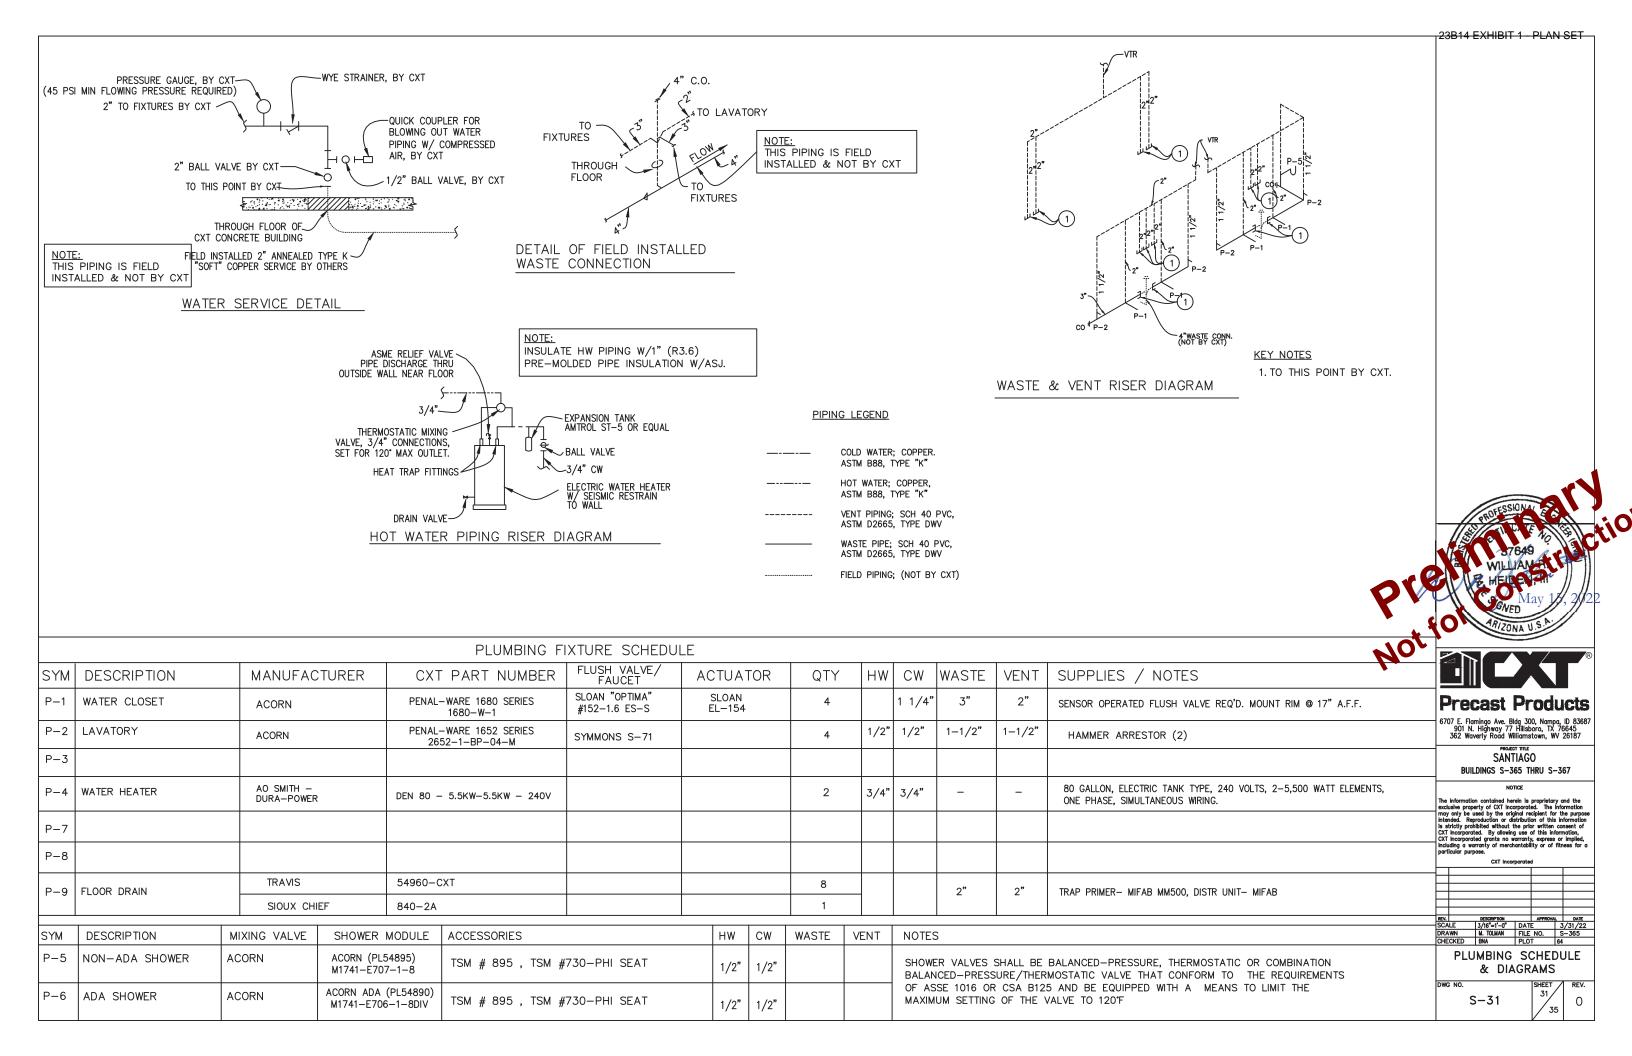

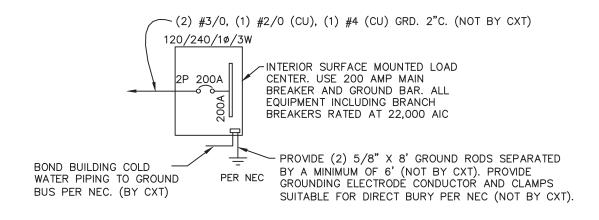ONE-LINE POWER DIAGRAM

NTS

GENERAL ELECTRICAL NOTES

- 1. RECESSED JUNCTION BOXES FOR SINGLE DEVICES SHALL HAVE SINGLE GANG MUD RINGS CAST IN
- 2. ALL RECEPTACLES SHALL BE GFCI PROTECTED BY CIRCUIT BREAKERS, OR BY OTHER GFCI RECEPTACLES.
- 3. ALL CONDUIT SHALL BE SIZED PER NEC. EXPOSED CONDUIT SHALL BE EMT/FMC, RECESSED SHALL BE
- 4. INSTALL ALL WIRING IN CONDUIT OR RELATED ENCLOSURES.
- 5. ALL ELECTRICAL INSTALLATIONS SHALL MEET THE 2017 NATIONAL ELECTRICAL CODE.
- 6. MINIMUM WIRE SIZE SHALL BE #12 AWG COPPER, THHN INSULATION UNLESS NOTED OTHERWISE.
- 7. ROUTE ALL CONDUITS IN UTILITY ROOM AT CEILING OR FACE OF WALLS.
- 8. ELECTRICAL DRAWINGS ARE DIAGRAMMATIC IN NATURE & MAY NOT SHOW EXACT LOCATIONS OF DEVICES. REFER TO WALL PANEL & OTHER DRAWINGS FOR EXACT LOCATIONS OF J-BOXES, ETC..
- 9. ALL CONDUCTORS AND CABLES MUST BE PROPERLY TERMINATED IN APPROVED BOXES, BEFORE CONNECTING THE CIRCUIT TO THE BREAKER AND BEFORE RECEIVING FINAL INSPECTION APPROVAL IN
- 10. CIRCUIT BREAKER LOCKOUTS REQUIRED FOR EACH HAND DRYER.
- 11. PROVIDE 2 POLE 60 AMP CIRCUIT BREAKER WIRED WITH #6 AWG

EXHAUST FAN SCHEDULE							
SYM	MFR	MODEL #	CFM	SONES	VOLTS	AMPS	NTS.
EF-1	FANTECH	FG-6XL	494	6.0	120	1.31	1

NOTE 1. INLINE CENTRIFUGAL FAN, PROVIDE DUCTING AND ROOF EXHAUST CAP.

				PA	ANELS	SCI	HE	DULE				
A٨	IP 200				P/	ANE	L		TOTAL CONNECTED VA	LOAD	29.31	12
	RFACE MOUNT				120/24			3W	TOTAL CALCULATED VA			
	novella en la el campionis conserval.								and all account of the control of th			
	CIRCUIT			LOAD				CIRCUIT			LOAD	
NO	DESCRIPTION	OCP	TYPE	(VA)	(A)	PH.	NO.	DESCRIPTION	OCP	TYPE	(VA)	(A)
1	LIGHTS AND EXHAUST FANS - SHOWERS	1P/20A	N	462	3.9	Α	2	LIGHTS AND EXHAUST FANS - RESTROOM	IS 1P/20A	R	462	3.9
3	RECEPTACLE - CHASE	1P/20A	R	180	1.5	В	4	LIGHTS - CHASE	1P/20A	N	56	0.5
5	OUTDOOR LIGHT	1P/20A	С	70	0.6	Α	6	HAND DRYER #1	1P/20A	N	1,140	9.5
7	HAND DRYER#2	1P/20A	L	1,140	9.5	В	8	HAND DRYER #3	1P/20A	N	1,140	9.5
9	RR RECEPTACLES	1P/20A	R	360	3.0	Α	10	RR RECEPTACLES	1P/20A	R	360	3.0
11		2P/60A	С	5,500	45.8	В	12	WATER HEATER#2	2P/60A	С	5,500	45.8
13	WATERTIERTER	2F/00A	С	5,500	40.0	Α	14	WATER HEATER #2	2F/00A	C	5,500	45.6
15	HAND DRYER#4	1P/20A	N	1,800	15.0	В	16	FLUSH SENSORS	1P/20A	R	142	1.2
17						Α	18					
19						В	20					
21						Α	22					
23						В	24			Т		
25						Α	26					
27						В	28			\top		
29			ı			Α	30			\top		
31						В	32					
	NOTE: MAXIMUM ALLOWABLE AIC IS 22K AMPS, PANEL N REQUIRED (NOT BYCXT) IF TRANSFORMER CAPACITY EX						(R) (N) (L)	AD ONTINUOUS EC (1ST 10KVA) DN-CONTINUOUS ARGEST MOTOR TOTAL LOAD	22,070 1,504 4,598	x1.25 x1.00 x1.00 x1.25	4,598 1,425 35,115	VA VA VA VA
ĺ												

			LIGHTING FIXTURE SCHEDULE
FIXTURE NUMBER	VOLTAGE	WATTS	DESCRIPTION
A	120	28	LUMINAIRE VPF84 INTERIOR LIGHT FIXTURE, VPF8-4-28W HP-4000K-120-CP-WHT-WET-OCC-TX/SD SURFACE MOUNTED, LED LAMP 4 FT, WRAP AROUND LENS, LOW TEMPERATURE DRIVER, BUILT IN OCCUPANCY SENSOR ACTIVATED W/ ADDITIONAL OCCUPANCY SENSOR FOR FAN CONTROL
В	120	14	SWOOP 610 LED EXTERIOR LIGHT, YWP610-14W HP-3500K-120-CP-BRZ-CAB/PC EXTERIOR, VANDAL RESISTANT, WALL MOUNTED, 14 WATT, CLEAR PRISMATIC LENS, BUILT IN PHOTOELECTRIC CONTROL
С	120	28	LUMINAIRE VPF84 INTERIOR LIGHT FIXTURE, VPF8-4-28W HP-4000K-120-CP-WHT-WET-TX/SD SURFACE MOUNTED, LED LAMP 4 FT, WRAP AROUND LENS, LOW TEMPERATURE DRIVER, WALL SWITCH CONTROL.

NOTE: THE SOURCE OF EFFICACY OF EXTERIOR LIGHTING IS TO BE A MINIMUM OF 45 LUMENS PER WATT.

R
Propost Products
Precast Products


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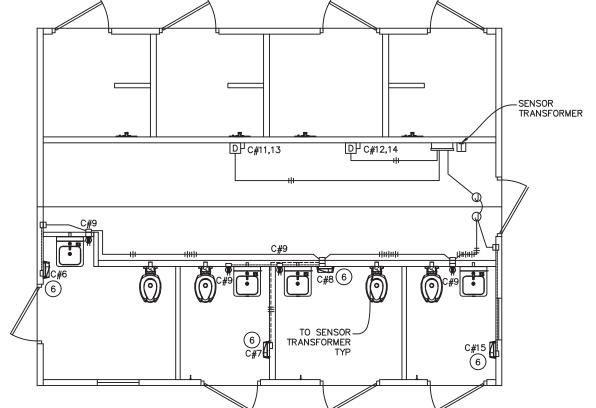
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		CXT Incor	norate	4		
	_	0A1 III00I	poraco	_		_
REV.		DESCRIPTION		APPROVA	L	DATE
SCA	LE	1/4"=1'-0"	DAT	E	-3	/31/22
DRA	WN	M. TOLMAN	FILE	NO.	S	-365
CHE	CKED	BNA	PLO	T	48	
	ELE	ECTRIC	AL.	NOI	ſΕ	s.

DETAILS, & SCHEDULE



LIGHTING & EXHUAST FAN PLAN

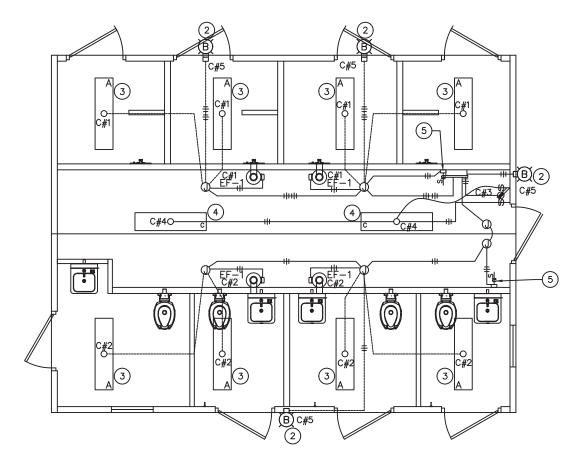

WATER HEATER & RECEPTACLE PLAN

KEY NOTES

- 1) WIRE EXHAUST FANS THROUGH OCCUPANCY SWITCH LOCATED IN LIGHT FIXTURE
- 2 EXTERIOR LIGHT FIXTURES TO BE CONTROLLED BY INTEGRAL PHOTOCELL
- 3 LIGHTS ARE OCCUPANCY SENSOR OPERATED.
- 4 CHASE LIGHTS ARE OCCUPANCY WALL SWITCH OPERATED.
- 5 PROVIDE ONE SPEED SWITCH PER EXHAUST FAN, ONLY 1 SHOWN FOR CLARITY.
- 6 HAND DRYERS

SYMBOLS

GFCI RECEPTACLE COMBINATION SWITCH & GFCI

JUNCTION BOX

CEILING MOUNTED LED FIXTURE

J () RECESSED JUNCTION BOX

LOAD CENTER "A"

 \boxtimes EXTERIOR LIGHT FIXTURE

HAND DRYER

O x

WATER HEATER

SAFETY DISCONNECT 마 CIRCUIT NUMBER C#XX

SURFACE MOUNTED CONDUIT, CROSSHATCH OR SLASH AND NUMBER DENOTES WIRES, (ALL #12AWG UNO, UNLESS NOTED)


ONE WIRE TO BE GROUND

CONCEALED CONDUIT

Precast Products

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SANTIAGO BUILDINGS S-365 THRU S-367

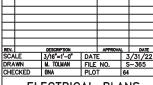

ELECTRICAL PLANS & NOTES

WALL PANEL W1		WALL PA	NEL W2	
EMBEDDED MATERIALS		EMBEDDED	MATERIALS	
ITEM	QTY	ITEM		QT
AS-2-S	4	AS-2-S	5	3
PS-2-S	10	PS-10-9	S	2
FL-648	4	PS-19-5	S	4
R411	4	R303		4
R320	12	PS-2-S	}	1
PS-19-S	6	R3x116		4
R303	6	R3x92		4
R316	1	R320		8
R327	2	R3x38		2
R3x64	2	R322		2
SI-2 MOLD	4	MS-2 BLOCK	(OUT	1
4x4 J-BOX	2	R3x96		2
ROUND MUD RING	2	SI-2 MOL	D	1
MS-2 B.O.	2	4x4 E-B0)X	2
R3x92	8	ROUND MUD	RING	1
R3x98	12			
R3x162	4			
R3x68	2			
R322	4			
3"x6"x2"DP PARTIAL B.O.	2			Г
40 1/8" x 82 1/4" B.O.	4			
· · · · · · · · · · · · · · · · · · ·				
MARINE PACKAGE REQUIRED		MARINE PACKAGE	REQUIRED	
	W.W.F.	CU. FT. CONC.	SQ. FT. W.W	l.F.
57.2 (2.12) 1	50	22.7 (0.84)	69	
approximate weight 8,590		approxima 3,4		
WALL PANEL W8 BLOCK	OUTS	WALL PA	NEL W9	
EMBEDDED MATERIALS		EMBEDDED	MATERIALS	

WALL PANEL W3			WA	LL P	ANEL \	N4	
EMBEDDED MATERIALS		lt		EMBEDDED	MATERIALS		
ITEM	QTY	-	AS-2-S	2	<u> </u>	ITEM	QT
AS-2-S	3		PS-10-S	1 2			+
PS-10-S	2		PS-2-S	4			
PS-19-S	14	-	R320	4	<u> </u>		╀
		┞	R3x65 R3x110	4	<u> </u>		╀
R303	4	┞	PS-3-S	1 2	-		+
PS-2-S	1		R303	2			+
R3x116	4		MARINE GRADE PKG RI	F0			F
R3x92	4		MARINE GRADE PAG RI	<u> </u>			+
R320	8	[CU. FT. CONC.		I. W.W.F.	APPROX CONC	WENCH
R3x38	2	L	18.2 (0.68)		55	2,735	
R322	2						
MS-2 BLOCKOUT	1						
	+						
	+						
	+						
	+-						

MARINE PACKAGE REQUIRED

APPROXIMATE WEIGHT 3,975

SQ. FT. W.W.F.

CU. FT. CONC.

26.5 (0.98)

4

4

4

4


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2

WAL	L P	ANEL \	V 5	
EM	BEDDED	MATERIALS		
ITEM	QTY		ITEM	QTY
AS-2-S	2			Т
PS-10-S	2			Т
PS-2-S	4			Т
R320	4			\top
R3x65	4			\top
R3x129	4			Т
PS-3-S	2			Т
R303	2			\perp
MARINE GRADE PKG REQ				t
CU. FT. CONC. 21.3 (0.79)		. w.w.f. 65	APPROX CONC 3,19	

EMI	EDDED	MATERIALS		
ITEM	QTY		ITEM	Q
AS-2-S	2			
PS-10-S	2			
PS-2-S	4			
R320	4			
R3x65	4			
R3x110	4			
PS-3-S	2			
R303	2			
MARINE GRADE PKG REQ				+
CU. FT. CONC. 18.2 (0.68)	SQ. FT.	w.w.f.		ONC WEIGH

WALL PA	NEL W7		WALL I
EMBEDDED	MATERIALS		EMBEDDE
ITEM		QTY	ITEN
AS-2-5	5	6	AS-
PS-2-9	3	10	PS-
FL-648		4	FL64
R411		4	R41
BLOCKOUT 6 1	/2" DIA	4	R32
PS-19-	S	6	R3x9
R303		6	R3x14
R320		4	R31
R316		1	R32
R327		2	PS-1
R3x172		6	R30
R3x92		20	R3x1
SHOWER WALL	SLEEVE	4	R3x10
MARINE PACKAGE	REQUIRED		
CU. FT. CONC.	SQ. FT. W.W	/.F.	CU. FT. CONC.
76.9 (2.85)	243		72.3 (2.67)
APPROXIMA			APPROXII
11,5	535		10
WALL PA	NFI W14		WALL F
WALL I A			TTALL I

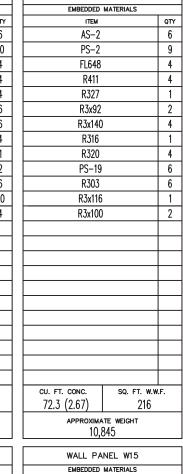

WALL PANEL W8

8,590	
WALL PANEL W8 BLOCKOUT	S
ITEM	QTY
W.C. WALL SLEEVE	4
TWO GANG MUD RING	4
B.O. 3" DIA	3
B.O. 1 1/2" DIA	3
RECT MUD RING	4
4x4 E-BOX	12
B.O. 6 1/2" DIA	4
3"x6"x2" DP PARTIAL B.O.	1
4x4 J-BOX	2
CU. FT. CONC. SQ. FT. W.W	<u> </u> /.F.
APPROXIMATE WEIGHT	

PANEL W8 BLOCKOL	JTS	WALL PA	NEL W9		WALL PA	NEL W10	
EMBEDDED MATERIALS		EMBEDDED	MATERIALS		EMBEDDED	MATERIALS	
ITEM	QTY	ITEM		QTY	ITEM		QTY
. WALL SLEEVE	4	AS-2		3	AS-2		3
GANG MUD RING	4	PS-10		2	PS-2		2
B.O. 3" DIA	3	PS-19		4	PS-10		2
O. 1 1/2" DIA	3	R303		2	PS-19		6
CT MUD RING	4	PS-2		1	R3x92		8
4x4 E-BOX	12	R3x116		4	R3x116		4
D. 6 1/2" DIA	4	R3x92		4	R320		16
" DP PARTIAL B.O.	1	R320		8	R303		2
4x4 J-BOX	2	R3x38		2	R3x48		2
		R322		4	B.O. 40 1/8" x	82 1/4"	1
		MS-2 BLOC	KOUT	1	SI-2		1
		R3x96		2	ROUND MUD	RING	1
		MS-4 B.	0.	1	4x4 J-B(XC	3
		4x4 J-B	XC	2	RECT MUD	RING	1
		RECT MUD	RING	1			
		R3x54		2			
CONC. SQ. FT. W	.w.F.	cu. ft. conc. 21.9 (0.81)	sq. ft. w.w 69	.F.	u. ft. conc. 18.8 (0.70)	sq. ft. w.w 80	.F.
PPROXIMATE WEIGHT		APPROXIMA 3,2			APPROXIMA 2,8		

	EMBEDDED M	ATERIALS		
ITEM	QTY	ITI	DM .	QTY
AS-2	2			
PS-15	2			
PS-2	4			П
R320	4			П
R3x72	4			П
R3x108	4			
				\perp
OU. FT. CONC. 14.7 (0.54)	so. FT. 1		PPROX CONC 2,205	WEIGHT

FM	BEDDED	MATERIALS		
ITEM	OTY	- AND	ITEM	QTY
AS-2	2			+
PS-10	2			\top
PS-2	4			\top
R320	4			Т
R3x72	4			Т
R3x129	4			
4x4 J-BOX	1			Т
RECT MUD RING	1			Т
3"x6"x2" DP PARTIAL B.O.	1			\perp
				ŧ
CU. FT. CONC.	SQ. FT	w.w.f.	APPROX CONC	WEIGHT
23.5 (0.87)		70	3.52	5

	EMBEDDED	MATERIALS		
ITEM	QTY	MATERIALS	ITEM	on
AS-2	2		1164	4
PS-15	2	_		+
	- 4			_
PS-2	4			
R320	4			
R3x72	4			
R3x114	4			
				_
	_			+
	_			+
CU. FT. CONC.			APPROX CO	
15.6 (0.57)		. w.w.f. 60		ис weight 340

WALL PANEL W14		WALL PA	NEL W15	
EMBEDDED MATERIALS		EMBEDDED	MATERIALS	
ITEM	QTY	ITEM		QTY
AS-2	2	AS-2		2
PS-2	4	PS-15		2 4
PS-15	2	PS-19		
R3x92	2	R303		4
R3x100	2	R320		8
R320	8	R3x100		1
B.O. 3" DIA	1			2.
B.O. 1 1/2" DIA	1		•	
4x4 E-BOX	2			
RECT MUD RING	1			
	\top			
	\top			
CU. FT. CONC. SQ. FT. V	W.W.F.	CU. FT. CONC.	SQ. FT. W.W.	F.
5.90 (0.21) 23	3	4.20 (0.15)	16	
APPROXIMATE WEIGHT			TE WEIGHT	
885		6.	30	



BUILDINGS S-365 THRU S-367

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art	icular purp	ose.				
		CXT Incor	porate	1		
EV.		DESCRIPTION		APPROVA		DATE
CA	LE	NTS	DAT	Ε	۳,	31/22
RA	WN	M. TOLMAN	FILE	NO.	S	-365
ΉE	CKED	BNA	PLO	T	-	
		MATERI	AL	LIS	T	

_T23B14 EXHIBIT 1 - PLAN SET

QTY	\perp	
10		
4		
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12		
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.F.		CL
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	5 10 4 4 6 10 4 12 2 1 3 2 4 6 6 6 6 6 6 6 6 2 3 1	5 10 4 4 6 10 4 12 2 1 3 2 4 6 6 6 6 6 6 6 6 2 3 1 1

		FLOOR SLAB F1	
		EMBEDDED MATERIALS	
	QTY	ITEM	QTY
	5	PS-19-S	19
	10	AS-5	7
	4	PT CHUCK	2
	4	R3x116	2
	6	R303	12
	10	1" PVC SCH40 x9'-6"	2
	4	R4x112	6
	12	R3x172	4
	2	R3x48	8
		R3x32	8
	3	R3x42	32
	2	RM54960 F.D.	4
	4	BLOCKOUT 8"x1'-0"	2
	6	AS-3	1
	6	B.O. 8" DIA	1
	6	SECTIONAL CONNECTION B.O.	2
	2		
	3		
	1		
	1		
	1		
	1		
		MARINE PACKAGE REQUIRED	
/. W	ı.F.	CU. FT. CONC. SQ. FT. W.W.	F.
-		107.8 (3.99) 520	
		APPROXIMATE WEIGHT	
		16,175	

FLOOR S		
EMBEDDED	MATERIALS	
ITEM		QTY
PS-19		25
AS-3		2
R3x72		4
R3x172		16
R4x112		10
R3x62		2
R3x42		32
RM54960	F.D.	4
AS-1		4
B.O. 24"x	24"	2
R303		10
R3x116		2
SECTIONAL BLO	OCKOUT	2 2 2 2
AS-5		2
1" PVC SCH40	x9'-6"	2
PT CHUC		2
		Ī
cu. ft. conc. 104.1 (3.85)	sq. ft. w.w 536	.F.
approxima 15,1		

ROOF SLAB R1-R		ROOF SL		
EMBEDDED MATERIALS		EMBEDDED	MATERIALS	
ITEM DC 10 C	QTY	PS-19-	<u> </u>	QTY
PS-19-S	11		-	13
FL-847	4	FL-847		4
FL-648	4	FL-648	}	4
R411	4	R411		4
R303	11	R303		13
R3x134	4	R3x134		4
R3x175	2	R3x175	i	2
R3x176	2	R3x176		2
R320	4	R320		4
1" PVC SCH40 x11'-0"	1	1" PVC SCH40	x11'-0"	1
PT CHUCK	1	PT CHUC	Ж	1
PS-2-S	2	PS-2-5	S	2
R4x18	16	R4x18		16
BLOCKOUT 5" DIA	1	B.O. 6 1/2'	' DIA	1
3"x6"x3" DP B.O.	1	3"x6"x3" DF	B.0.	1
4x4 J-BOX	3	4x4 J-B	OX	3
BLOCKOUT 6 1/2" DIA	1	ROUND MUD	RING	2
ROUND MUD RING	2			
MARINE PACKAGE REQUIRED		MARINE PACKAGE	REQUIRED	
CU. FT. CONC. SQ. FT.	W.W.F.	CU. FT. CONC.	SQ. FT. W.W	/.F.
71.3 (2.64) 34	4	71.3 (2.64)	344	
APPROXIMATE WEIGHT 10,695		APPROXIMA 10,0		

EMBEDDED	MATERIALS	
ITEM	MATERIALS	QTY
PS-19)	16
PS-2		3
FL648		4
FL847		4
R411		4
R303		16
R320		4
R3x176	3	2
R3x134	1	4
R3x175	5	2
R4x18		16
BLOCKOUT S	5" DIA	2
4x4 J-B		3
3"x6"x3" DP B.O.		1
ROUND MUD		2
B.O. 6 1/2	" DIA	1
1" PVC SCH40		1
PT CHU	CK	1
CU. FT. CONC.	SQ. FT.	
71.3 (2.64)] 3	40
	ate weight 695	

	ROOF SLAB R2-L	
	EMBEDDED MATERIALS	
QTY	ITEM	QTY
16	PS-19	17
3	PS-2	3
4	FL648	4
4	FL847	4
4	R411	4
16	R303	17
4	R320	4
2	R3x176	2
4	R3x134	4
2	R3x175	2
16	R4x18	16
2	BLOCKOUT 5" DIA	1
3	4x4 J-BOX	3
1	ROUND MUD RING	1
2	B.O. 6 1/2" DIA	1
1	1" PVC SCH40 x11'-0"	1
1	PT CHUCK	1
1		
		\top
+		$\dagger \lnot$
w.w.f. 0	cu. ft. conc. sq. ft. w. 71.3 (2.64) 340	.W.F.
<u> </u>	APPROXIMATE WEIGHT 10,695	

\vdash	EMBEDDED	MATERIALS	
Т	ITEM		QT
	PS-20-	S	2
	B-18		1
L			
L			
L			
L	MARINE PACKAG		
	CU. FT. CONC.	SQ. FT. W	.W.F.
_	2.9 (0.12)	11	
	APPROXIMA	TE WEIGHT	

ST649

WILLIAM AT

HEIDEL FAT

ARIZONA U.S.A.



6707 E. Flamingo Ave. Bldg 300, Nampa, ID 83687 901 N. Highway 77 Hillsboro, TX 76645 362 Waverly Road Williamstown, WV 26187

SANTIAGO
BUILDINGS S-365 THRU S-367

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CXT Incorporated

LX. DESCRIPTION APPROVA. DATE

CALE NTS DATE 3/31/22

RAWN M. TOLMAN FILE NO. S-365

HECKED BNA PLOT -

MATERIAL LIST

DWG NO.

S-35

35 REV.